DEPARTMENT OF STATE POLICE NORTHVILLE FORENSIC LABORATORY


42145 West Seven Mile Road, Northville, Mi. 48167

ELEVATOR REPLACEMENT


State Facilities Administration

The Department of Technology, Management, and Budget

The State of Michigan

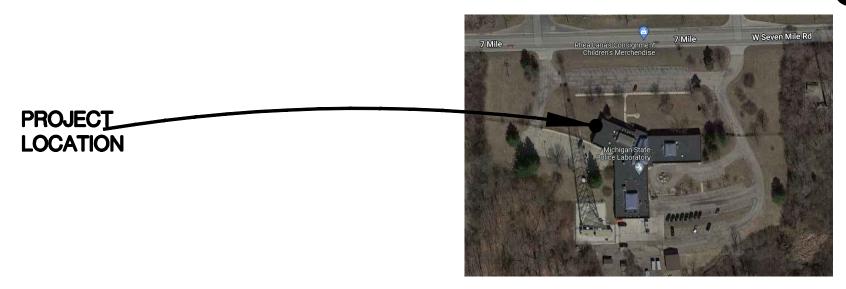



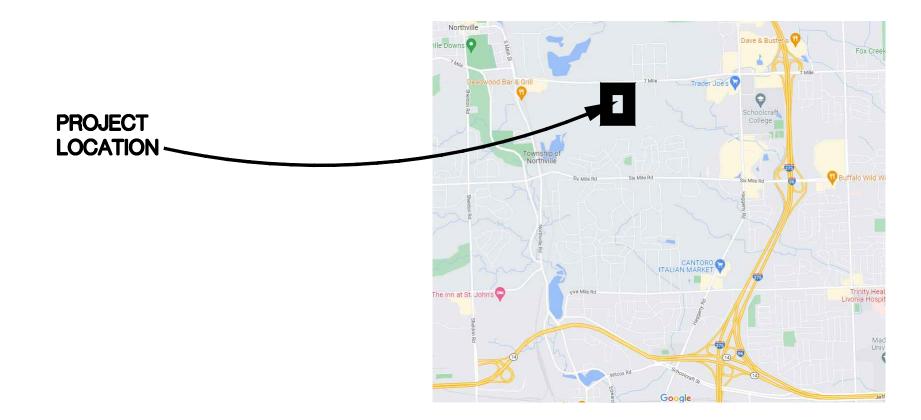

SITE VICINITY MAP SCALE - N.T.S.

MEP ENGINEERS

MATRIX CONSULTING ENGINEERS, INC.

1601 E. Cesar E. Chavez Ave. Lansing, Michigan 48906 PH: (517) - 487 - 2511 FAX: (517) - 487 - 2544

ARCHITECT OF RECORD

HOBBS + BLACK ARCHITECTS 100 N. STATE ST. ANN ARBOR, MI 48104 PH: (734) 663 - 4189 FAX: (734) 663 - 1770

D-100 DEMOLITION WORK

MECHANICAL \ ELECTRICAL

M-100 MECHANICAL SYMBOLS, ABBREV., NOTES, SCHEDULES

M-402 PARTIAL ROOF LEVEL FLOOR PLAN - HVAC NEW

LOWER LEVEL FLOOR PLAN - PLUMBING DEMOLITION

ELECTRICAL DEMOLITION FLOOR PLANS

PARTIAL LOWER LEVEL FLOOR PLAN ELECTRICAL

PARTIAL ROOF PLAN ELECTRICAL

DRAWING INDEX

M-400 PARTIAL LOWER LEVEL FLOOR PLAN - HVAC NEW PARTIAL UPPER LEVEL FLOOR PLAN - HVAC NEW

P-100 PLUMBING SYMBOLS, ABBREV, NOTES, SCHEDULES

PARTIAL BELOW LOWER LEVEL FLOOR PLAN - PLUMBING NEW PARTIAL LOWER LEVEL FLOOR PLAN - PLUMBING NEW

ELECTRICAL SYMBOLS, ABBREV., NOTES, SCHEDULES

ELECTRICAL POWER FLOOR PLANS

ELEVATOR SPECIALIST

LERCH BATES ELEVATOR CONSULTING 950 BOSTON STREET SE GRAND RAPIDS, MI 49507 PH: (616) 216-2058



TITLE SHEET **INDEX**

MSP

NORTHVILLE LAB

ELEVATOR

REPLACEMENT

MATRIX
CONSULTING ENGINEERS INC.

1601 E César E. Chávez Ave Lansing, MI 48906

Lerch Bates

950 Boston Street SE Grand Rapids MI 49507

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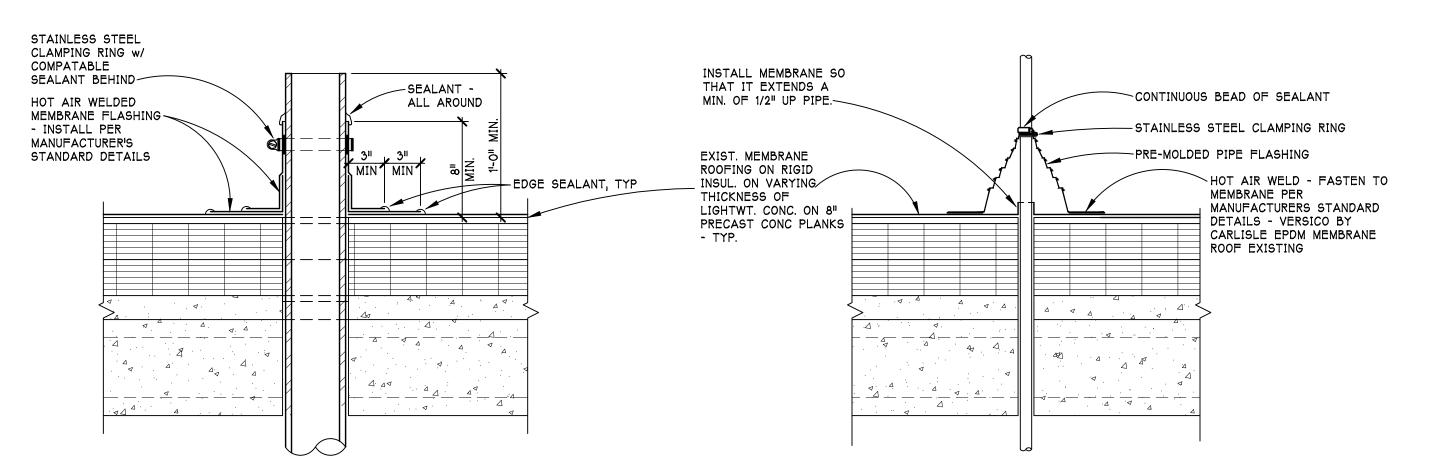
SHEET TITLE

CONSULTANT

22300

PROJECT NUMBER

A-000



H5 TYP. PLUMBING VENT SCALE - 1 1/2" = 1'-0"

SINGLE PIPE / CONDUIT ROOF PENETRATION SCALE - 1 1/2" = 1'-0"


GENERAL NOTES:


- 1. ALL WORK SHALL BE EXECUTED IN ACCORDANCE WITH THE STATE OF MICHIGAN STANDARDS INCLUDING, BUT NOT LIMITED TO THE FOLLOWING: 2015 MICHIGAN REHABILITATION CODE FOR EXISTING BUILDINGS 2015 MICHIGAN BUILDING CODE 2015 MICHIGAN MECHANICAL CODE
 - 2015 MICHIGAN PLUMBING CODE 2015 MICHIGAN COMMERCIAL ENERGY 2010 MICHIGAN DEPT OF LICENSING & REGULATORY AFFAIRS - MICHIGAN
 - ELEVATOR RULES ASME A17.1 - 2016 SAFETY CODE FOR ELEVATORS AND ESCALATORS 2010 ADA STANDARDS FOR ACCESSIBLE DESIGN
- 2. ALL MATERIALS SHALL BE NEW UNLESS OTHERWISE NOTED.
- 3. WORK IMPLEMENTED IN EXISTING FIRE-RATED PARTITIONS SHALL MAINTAIN THE RATING OF THE PARTITION. WHERE REQUIRED, PROVIDE ADDITIONAL LAYERS OF FIRE-RATED GYPSUM BOARD TO MAINTAIN THE EXISTING FIRE RATING OVERLAPPED AS REQUIRED BY UL
- STANDARDS. 4. FURNISH AND INSTALL SHEET METAL OR FIRE TREATED WOOD BLOCKING IN AMENDED PARTITIONS TO PROPERLY ANCHOR WALL-ATTACHED ITEMS. FIXTURES, AND EQUIPMENT.
- 5. FURNISH ALL COMPONENTS AND ACCESSORIES FOR ACCESSIBLE ROUTES REQUIRED BY FOR ADA (AMERICANS WITH DISABILITIES ACT) AND STATE OF MICHIGAN COMPLIANCE.
- 6. DRAWINGS ARE PROVIDED FOR REFERENCE ONLY. FOLLOW ONLY PROVIDED DIMENSIONS AND DO NOT SCALE OFF
- DRAWINGS. 7. DURING CONSTRUCTION, CONTRACTORS SHALL PROTECT EXISTING WORK AND SHALL TAKE PRECAUTIONS NOT TO DAMAGE ANY EXISTING MATERIALS, ITEMS, OR CONDITIONS. REPAIR AND /OR REPLACE ALL DAMAGED ITEMS TO APPEAR AS NEW WITHOUT EXTRA COST TO THE OWNER.
- 8. SEAL ALL FLOOR / WALL PENETRATIONS AROUND ALL CONDUITS, DUCTS, OPENINGS, TO MAINTAIN EXISTING AND NEW WALL FIRE RATINGS.
- 9. ALL WORK SHOWN SHALL BE INCLUDED IN THE SCOPE OF WORK, UNLESS OTHERWISE NOTED AS "NOT IN CONTRACT", OR "N.I.C."
- 10. VERIFY ALL ELEVATOR HOISTWAY DIMENSIONS, DOOR OPENING CLEARANCES AND HEIGHTS. PROVIDE EQUIPMENT WHICH WILL FIT IN/THROUGH THE EXISTING OPENINGS AVAILABLE..
- 11. ELEVATOR CAB TO BE IN ACCORDANCE SECTION 408.4.1 2010 ADA STANDARDS FOR ACCESSIBLE DESIGN.

<u>ALLOWABLE BUILDING HEIGHT & AREA:</u>

CONSTRUCTION TYPE IB - EXISTING TO REMAIN BUILDING HEIGHT/AREA - EXISTING TO REMAIN

SPRINKLER SYSTEM - FULL AUTOMATIC SPRINKLER

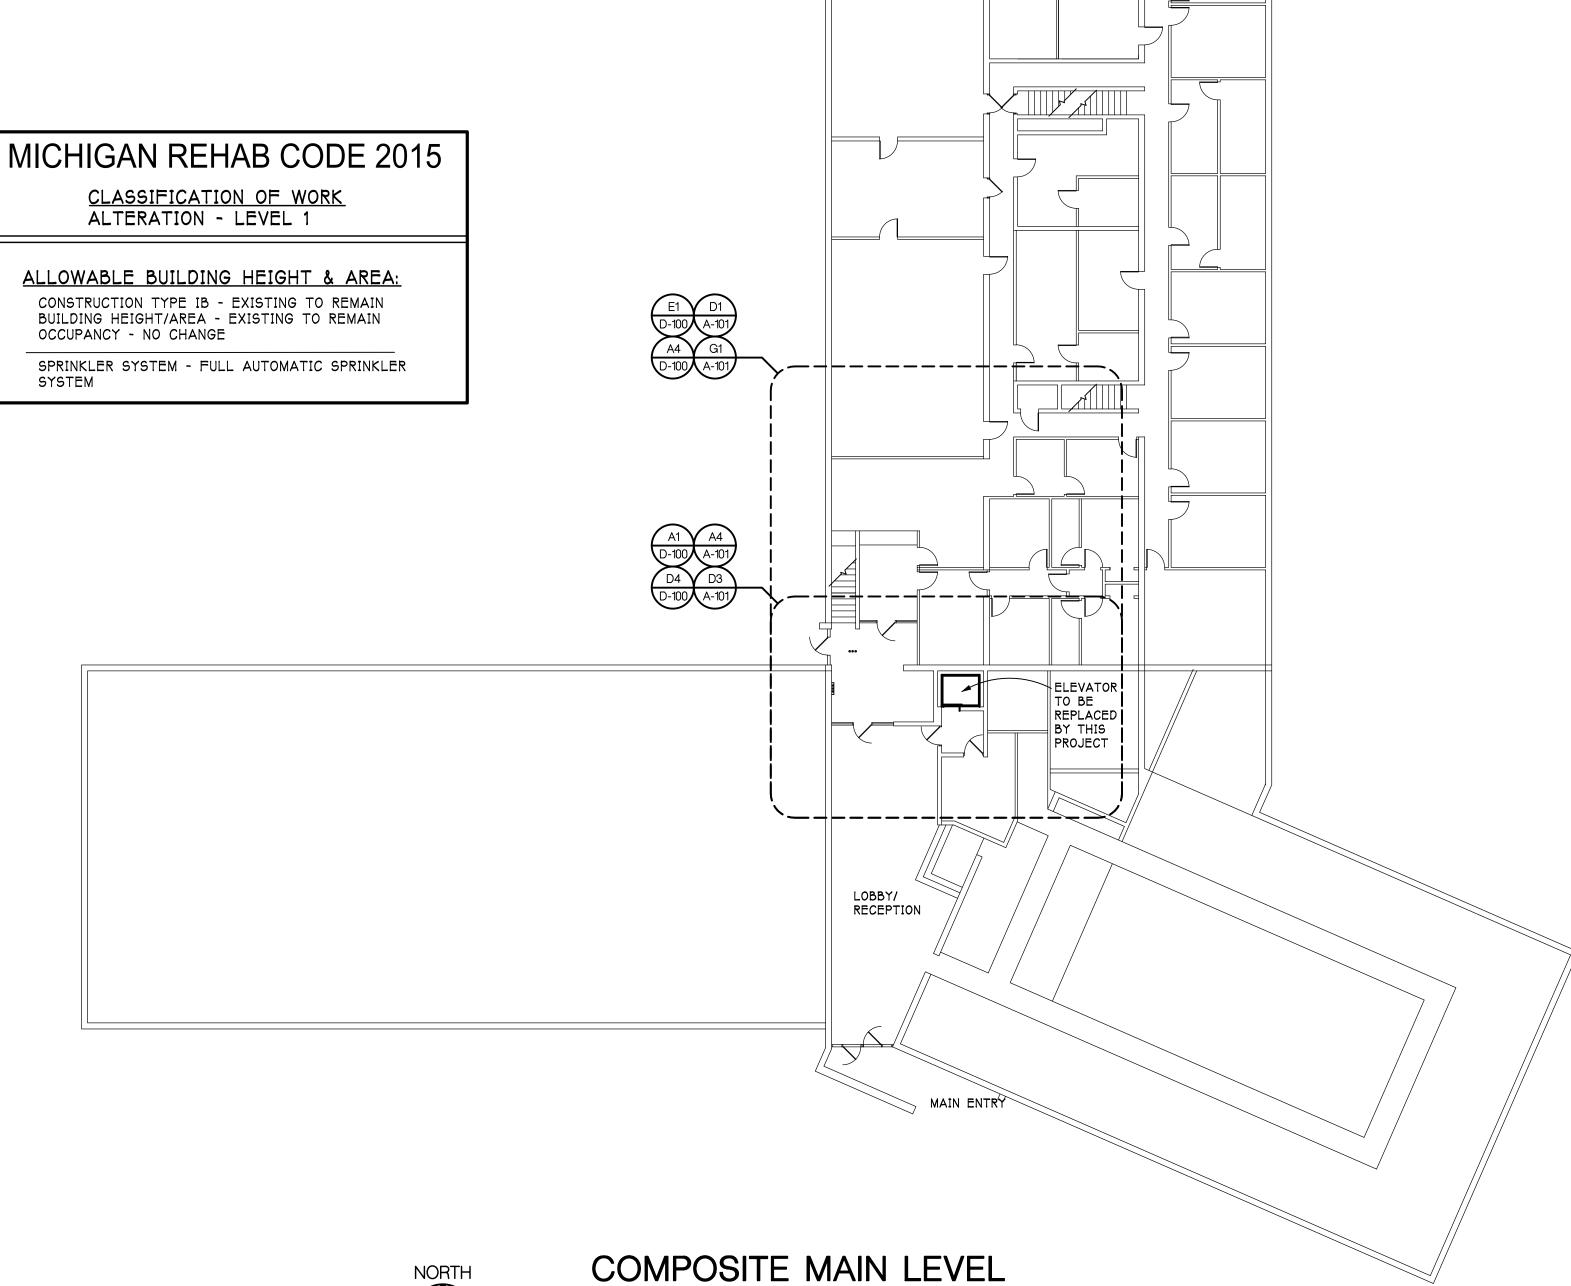

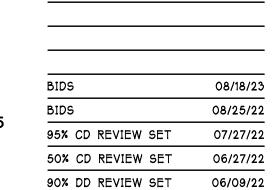

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MSP NORTHVILLE LAB **ELEVATOR** REPLACEMENT

 42145 W SEVEN MILE RD., NORTHVILLE, MI 48167

PROJECT





950 Boston Street SE Grand Rapids MI 49507 CONSULTANT

COMPOSITE PLAN & NOTES & **CODE INFORMATION**

SHEET TITLE

22300

ARCHITECT

1301014119,


PROJECT NUMBER


A-100


FLOOR PLAN

SCALE - 1/16" = 1'-0"


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PARTIAL FLOOR PLAN AT LOWER LEVEL

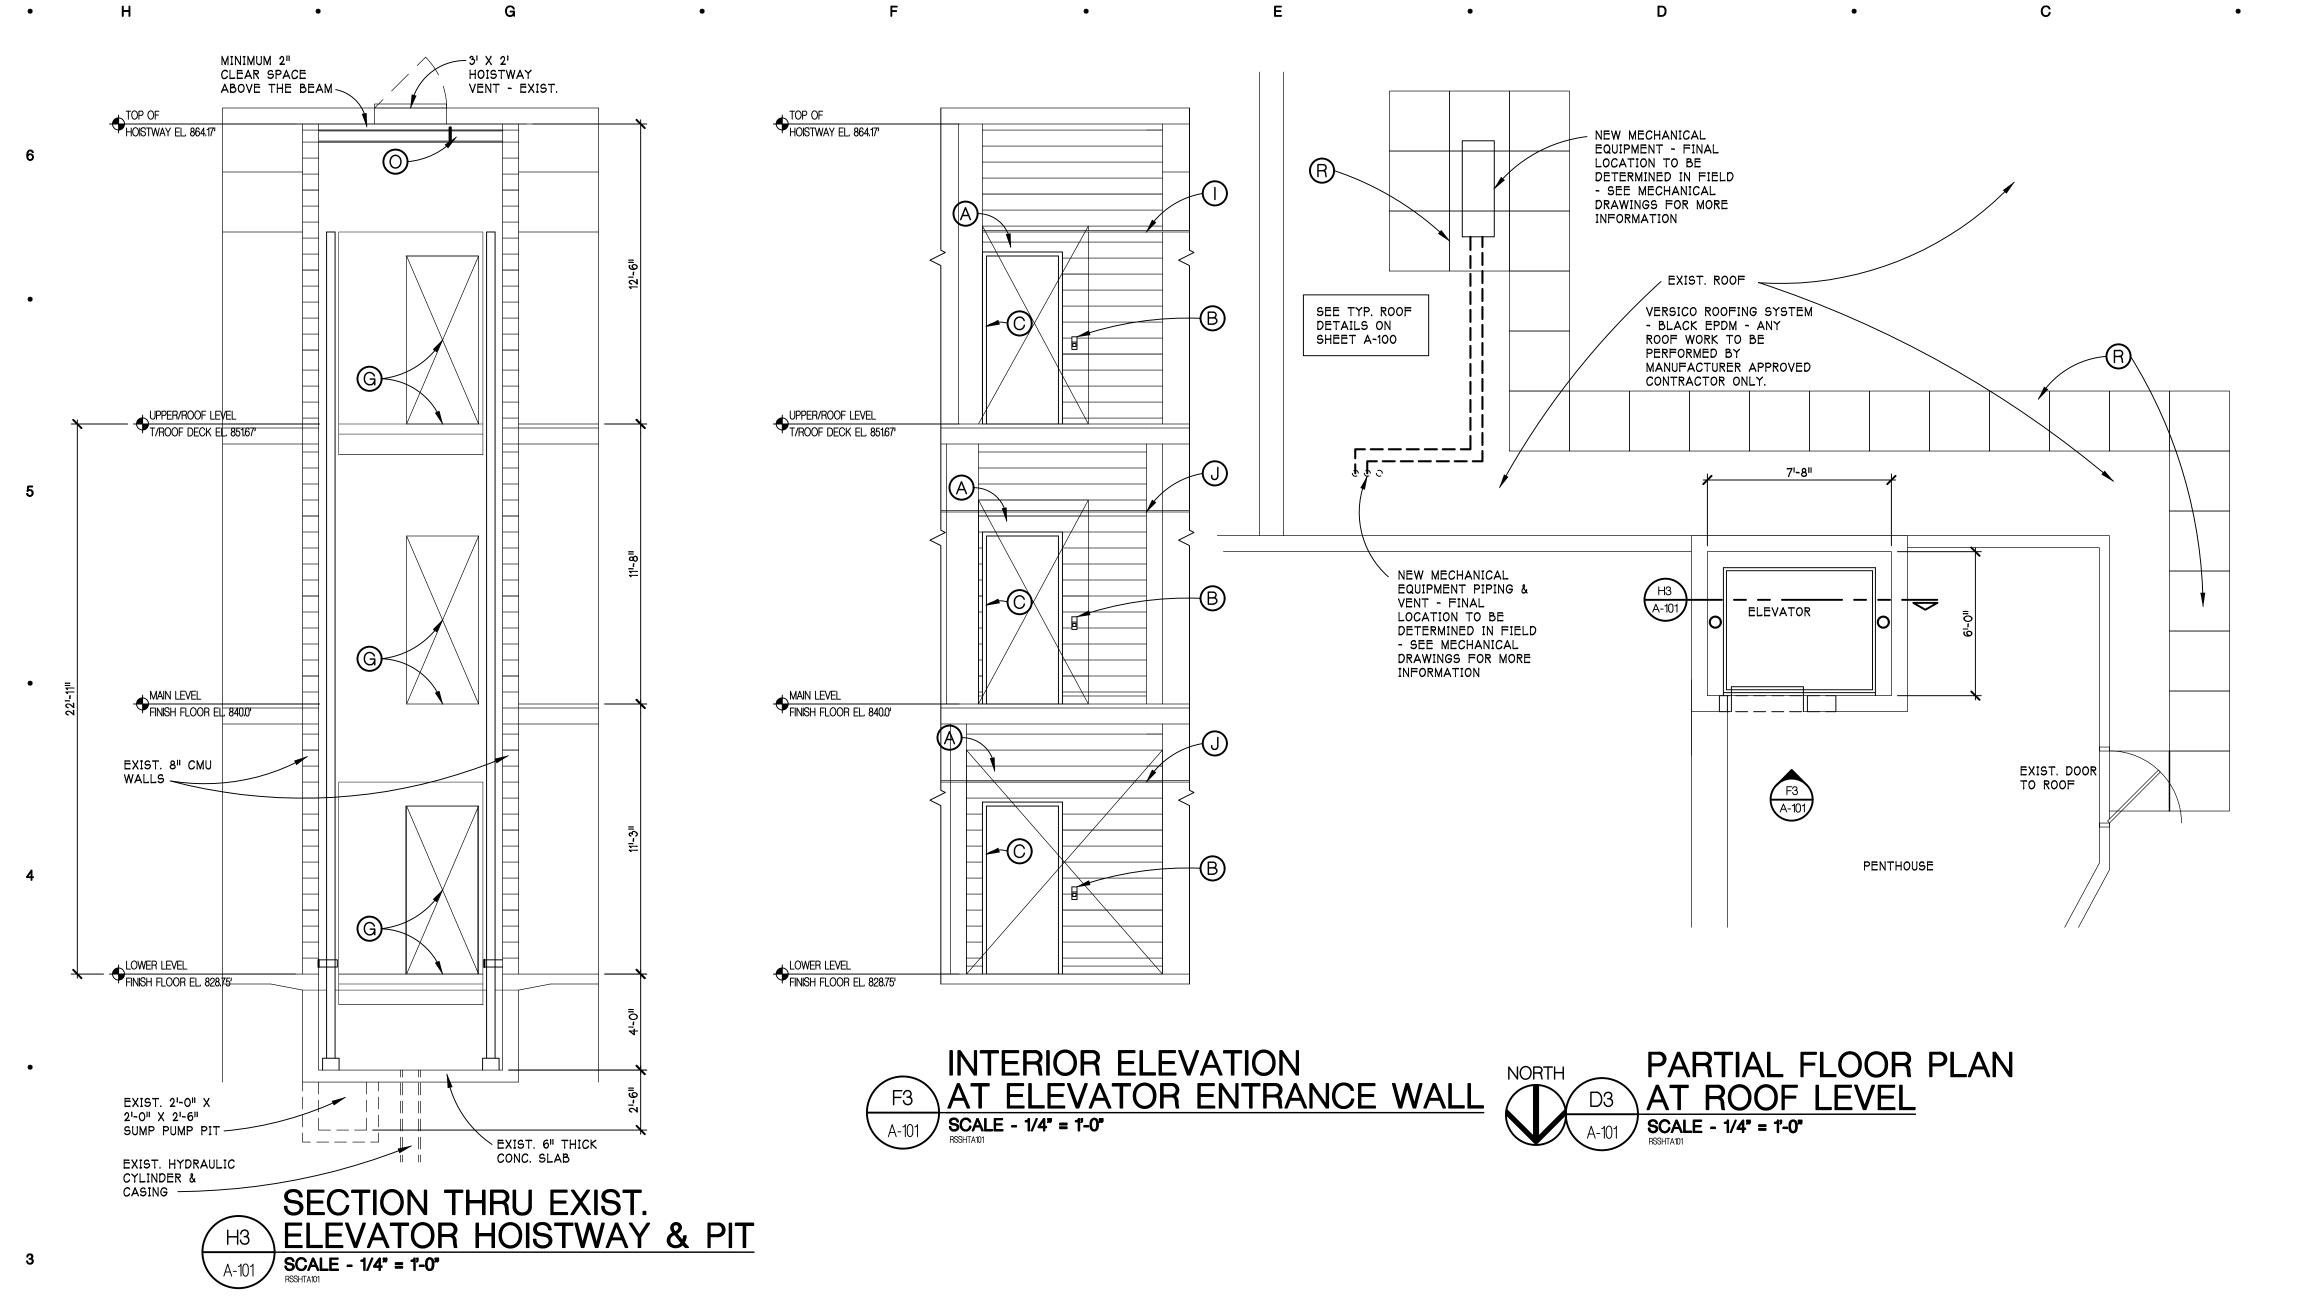

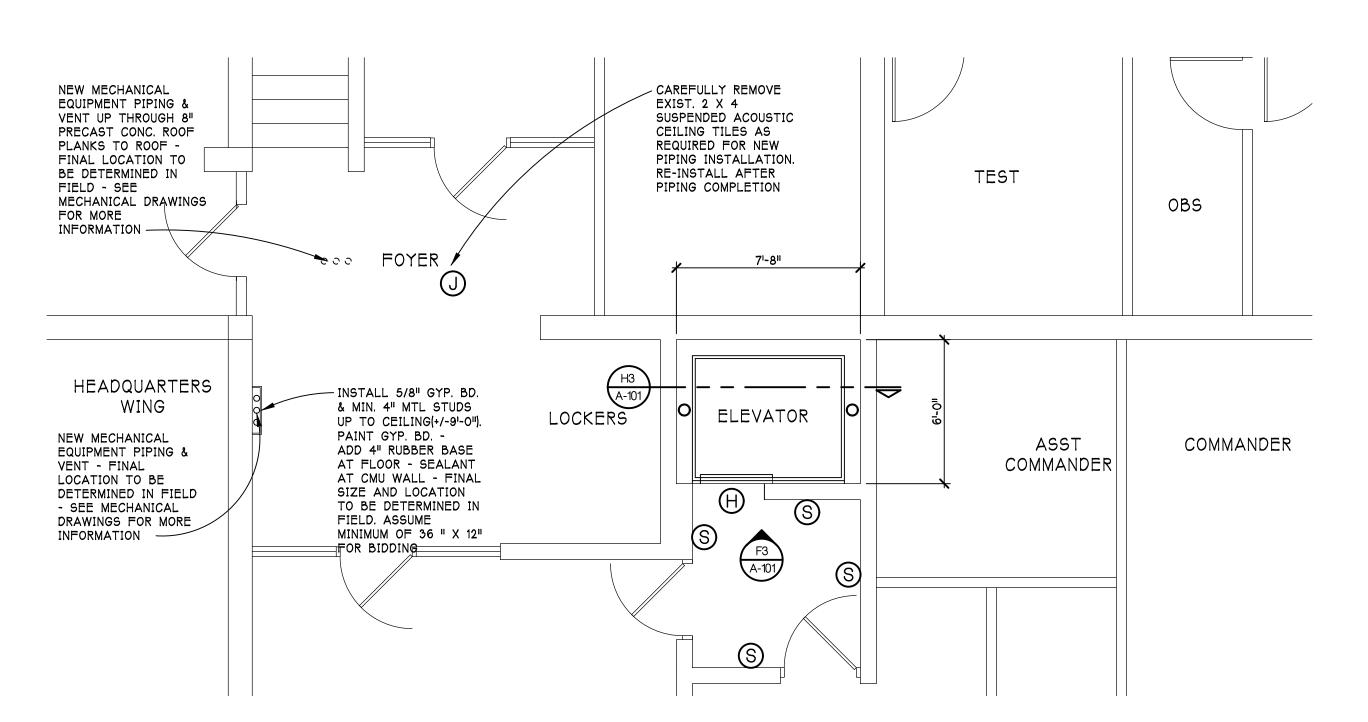PARTIAL FLOOR PLAN A4 AT PIT LEVEL SCALE - 1/4" = 1'-0"

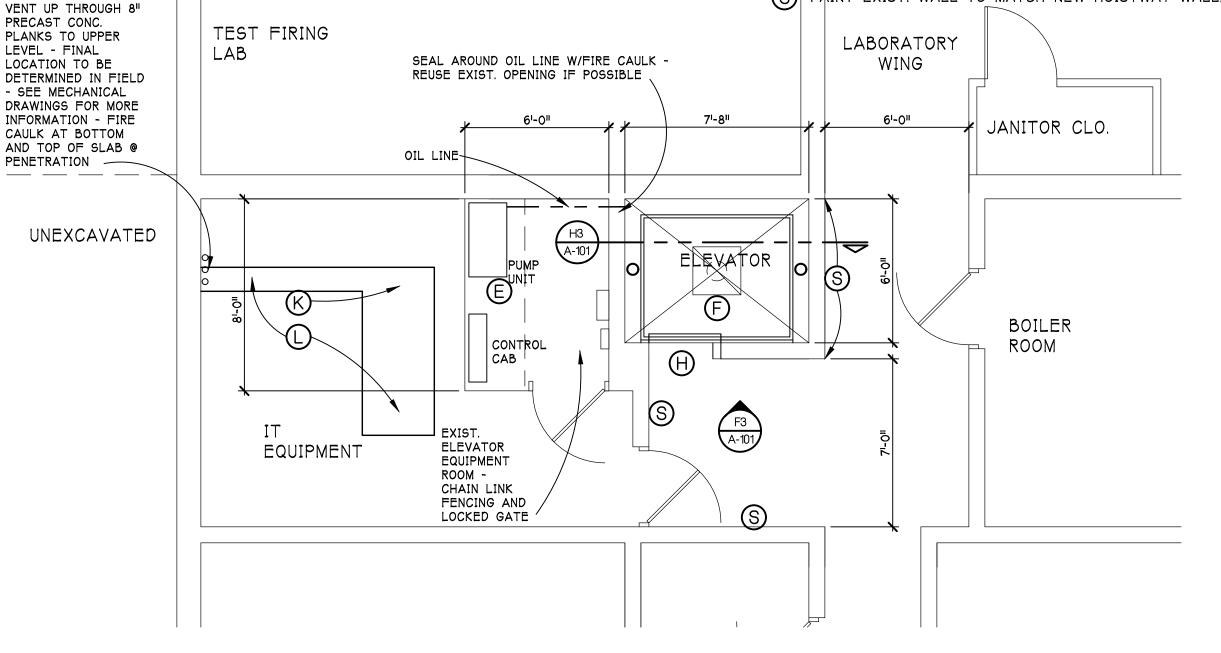NEW CONSTRUCTION KEY NOTES

- INSTALL NEW CMU WALL AND/OR CMU INFILL AROUND NEW JAMBS. PAINT CMU - SHERWIN WILLIAMS CITY LOFT #7631 PROVIDE CONCRETE OR CMU LINTELS - TYP. - REPLACE EXIST. VINYL BASE AS REQUIRED.
- B INSTALL NEW ELEVATOR CALL BUTTON PANEL
- INSTALL NEW DOOR OPENING JAMBS PAINT SHERWIN WILLIAMS INDIGO BATIK #7602
- INSTALL NEW HYDRAULIC HOLE-LESS CYLINDERS APPROX. LOCATIONS
- E INSTALL NEW ELEVATOR MACHINERY, PANELS ETC.
- F INSTALL NEW ELEVATOR CAR COMPLETELY INTERIOR FINISHED OUT PER THE SPECIFICATIONS
- INSTALL NEW ELEVATOR SILL & DOORS ETC.
- PROTECT EXIST. FLOORING IN AREA IMMEDIATELY OUTSIDE OF THE NEW SILLS. IF TOO DAMAGED TO PATCH SATISFACTORILY, REPLACE WITH SAME MATERIAL
- PATCH & PAINT GYP. BD. CEILING ABOVE AS REQUIRED
- J PATCH SUSPENDED ACOUSTIC CEILING ABOVE AS REQUIRED
- K INSTALL NEW IN-GROUND OIL INTERCEPTOR SEE MECHANICAL
- PATCH EXISTING CONCRETE FLOOR OVER/AROUND NEW OIL INTERCEPTOR & UG VENT. EXIST. CONC SLAB = 4" CONC SLAB W/4 X 4 10/10 WWF ON COMPACTED FILL.
- (M) CLEAN AND PAINT PIT FLOOR
- (N) CLEAN AND PAINT EXISTING PIT LADDER
- INSTALL NEW HOIST BEAM W8 x 24
- P SEAL CYLINDER CASING FLOOR OPENING
- NEW ELEVATOR BUFFER APPROX. LOCATIONS
- (R) NEW ROOF WALK PADS
- S PAINT EXIST. WALL TO MATCH NEW HOISTWAY WALL/PATCH

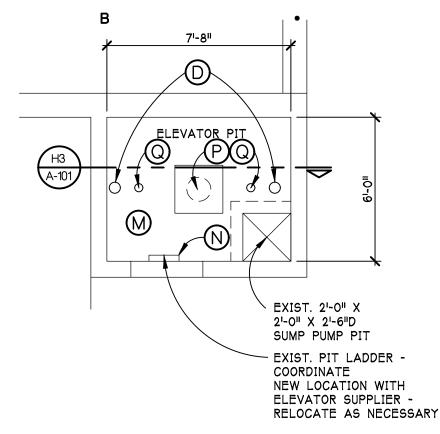

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NORTHVILLE LAB

ELEVATOR

REPLACEMENT

42145 W SEVEN MILE RD.,

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FLOOR PLANS, **ELEVATION & SECTION**

SHEET TITLE

22300

PROJECT NUMBER

A-101


PARTIAL FLOOR PLAN AT MAIN LEVEL

NEW MECHANICAL

EQUIPMENT PIPING &


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1301014119,

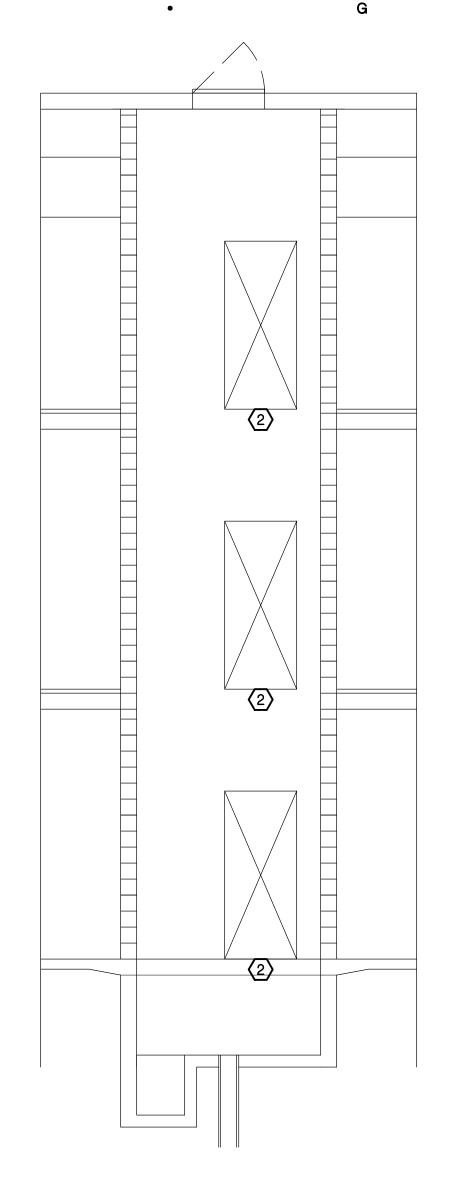


DEMO SECTION AT EXIST. HOISTWAY

D-100 SCALE - 1/4" = 1'-0"

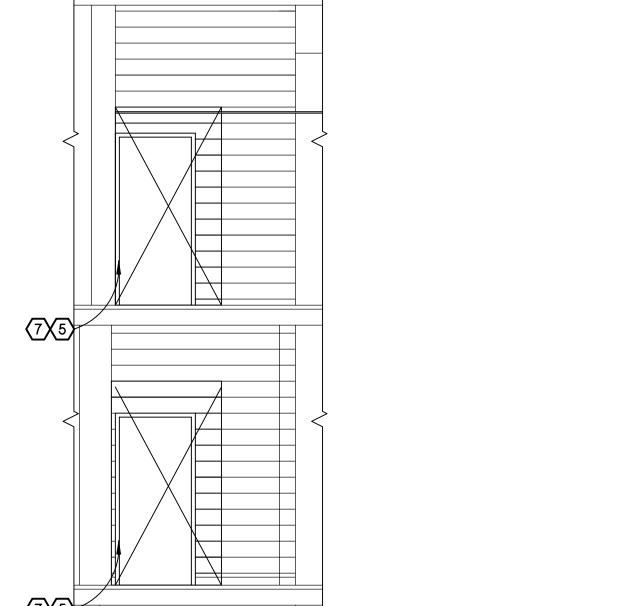



DEMO ELEVATION
AT ELEVATOR ENTRANCE WALL

SCALE - 1/4" = 1'-0"

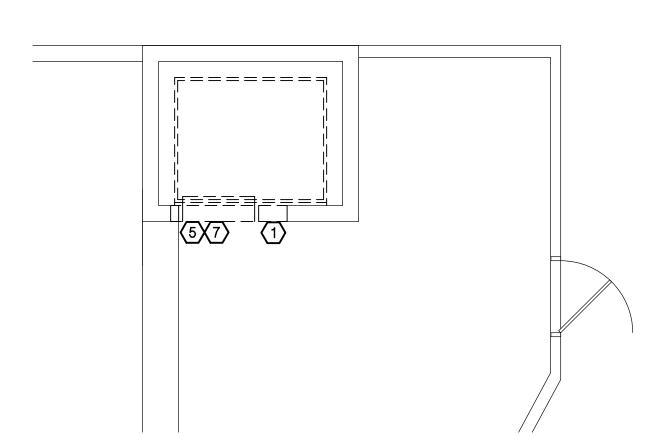




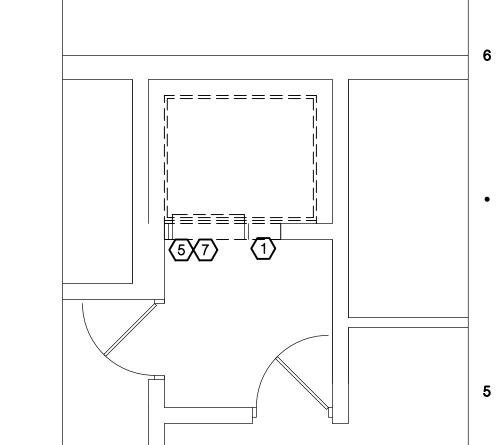

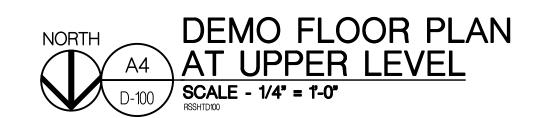


DEMOLITION KEY NOTES

- 1 REMOVE EXISTING ELEVATOR CALL BUTTON PANEL
- 2 REMOVE EXISTING ELEVATOR MACHINERY, RAILS, SILLS, DOORS, CAB ETC.
- REMOVE EXISTING ELEVATOR ELECTRICAL EQUIPMENT SEE ELECTRICAL DRAWINGS FOR TERMINATION INFORMATION
- REMOVE EXISTING ELEVATOR RELATED MECHANICAL EQUIPMENT SEE MECHANICAL DRAWINGS FOR MORE INFORMATION
- 5 REMOVE EXISTING ELEVATOR DOOR JAMBS
- 6 REMOVE EXISTING CMU AS REQUIRE FOR NEW CYLINDERS INSTALLATION
- REMOVE EXISTING CMU AS REQUIRED TO INSTALL NEW DOOR JAMBS AND CALL BUTTONS
- REMOVE EXISTING CONCRETE FLOOR AS REQUIRED TO INSTALL NEW OIL INTERCEPTOR AND SANITARY PIPING SEE PLUMBING DRAWINGS FOR MORE DETAIL
- 9 REMOVE EXISTING HYDRAULIC CYLINDER STEEL CASING TO REMAIN

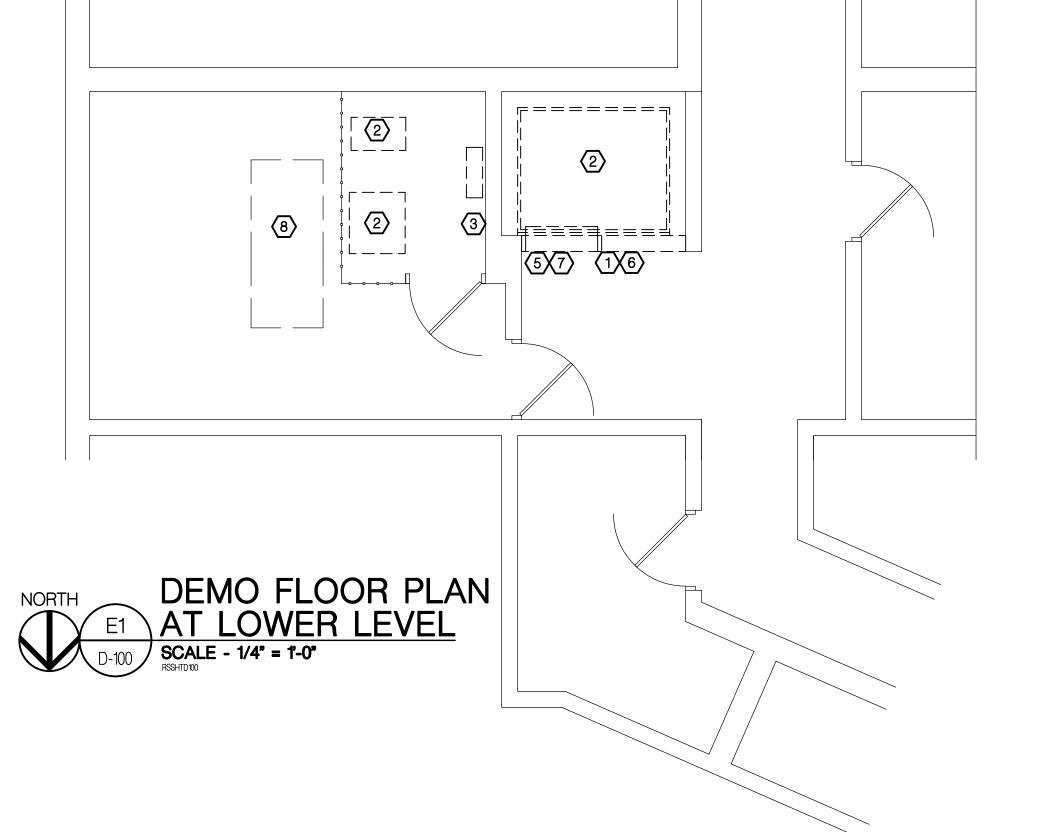

С

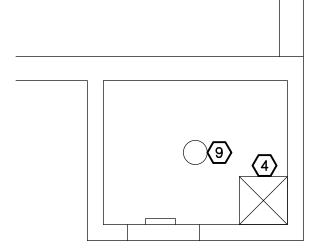

DEMO FLOOR PLAN
AT PIT LEVEL

SCALE - 1/4" = 1'-0"

WILLIAM S
HOBBS

ARCHITECT

NO
1301014119

VSED ARCHITECT

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BIDS 08/25/22
95% CD REVIEW SET 07/27/22
50% CD REVIEW SET 06/27/22
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50% DD REVIEW SET 05/19/22

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MSP NORTHVILLE LAB ELEVATOR REPLACEMENT

 42145 W SEVEN MILE RD., NORTHVILLE, MI 48167

PROJECT





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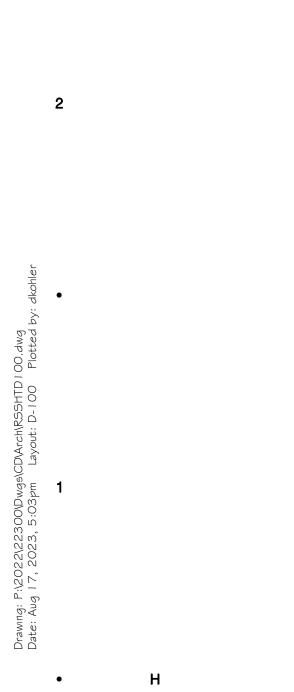
DEMOLITION WORK

SHEET TITLE

22300

PROJECT NUMBER

D-100



MECHANICAL ABBREVIATIONS

ABOVE FINISH FLOOR INSIDE DIAMETER AIR COMPRESSOR INVERT ELEVATION INTAKE HOOD AIR HANDLING UNIT AHU AIR SEPARATOR ARCHITECTURAL TRADES CONTRACTOR LEAVING AIR TEMPERATURE LATENT HEAT (MBH) LEAVING WATER TEMPERATURE BUILDING AUTOMATION SYSTEM B.A.S. MAXIMUM COMBUSTION AIR FAN MBH COOLING COIL MINIMUM CFM CUBIC FEET PER MINUTE M.T.C.

BTU PER HOUR (THOUSAND) MECHANICAL TRADES CONTRACTOR CHLR CONSOLE HEAT PUMP NOISE CRITERIA CONV NATIONAL FIRE PROTECTION ASSOCIATION CONVECTOR COOLING TOWER NOT TO SCALE CONDENSING UNIT

CABINET UNIT HEATER CONTROL VALVE PCR PUMPED CONDENSATE RETURN CHILLED WATER PUMP PRESSURE DROP DRY BULB RADIANT CEILING PANEL DUCT FURNACE REQ'D REQUIRED DIAMETER RETURN GRILLE DOWN RELATIVE HUMIDITY DPR DAMPER RELIEF HOOD DUCT SILENCER ROOF TOP UNIT

SUPPLY DIFFUSER

SENSIBLE HEAT (MBH)

TOTAL COOLING (MBH)

TEMPERATURE CONTROL

VARIABLE AIR VOLUME BOX

VARIABLE FREQUENCY DRIVE

VARIABLE AIR VOLUME REHEAT BOX

FAN POWERED VARIABLE AIR VOLUME BOX

EXISTING ITEM (EXISTING SUPPLY AIR DUCT)

POINT OF CONNECTION BETWEEN NEW AND

POINT OF EXISTING TO REMAIN AND EXISTING TO BE REMOVED

SATURATED SUCTION TEMPERATURE

TEMPERATURE & PRESSURE RELIEF VALVE

SUPPLY FAN

SUPPLY GRILLE

SHEET METAL

SQUARE FEET

UNIT HEATER

ZONE DAMPER

HVAC DUCTWORK & DIFFUSER TAGS

NECK REMARKS

INDICATES PLAN NOTE

DETAIL BUBBLE

XXXX PAGE LOCATION INDICATES

XX DETAIL NUMBER

INDICATES DEMOLITION NOTE

DIRECTION OF DETAIL SECTION

SIZE

MISCELLANEOUS NOTES

EXISTING

STRAINER

SQ. FT.

STR

T&P

TYP

FPVAV

V.F.D

ENTERING AIR TEMPERATURE EXHAUST FAN EXHAUST GRILLE ELECTRICAL TRADES CONTRACTOR EVR **EVAPORATOR** EWT ENTERING WATER TEMPERATURE EXH EXHAUST EXIST **EXISTING**

MECHANICAL SYMBOLS LEGEND

FTR FINNED TUBE RADIATION **FURNACE GALLON** GFRH GAS FIRED RADIANT HEATER GR GRILLE

FINISH FLOOR

FEET PER MINUTE

HUMIDIFIER **HEATING COIL** HEAD (FT) HORSE POWER HORIZONTAL HEAT PUMP HTG

HVAC DUCTWORK SYMBOLS

SUPPLY AIR DUCT RISER

RETURN AIR DUCT RISER

EXHAUST AIR DUCT

-√-

-

OUTSIDE AIR DUCT RISER (AS NOTED)

INSULATED DUCTWORK (AS NOTED)

SUPPLY AIR DIFFUSER (SQUARE)

SUPPLY AIR DIFFUSER (INLINE)

SUPPLY AIR DIFFUSER (ROUND)

CONICAL TAKE-OFF W/ DAMPER

SURFACE MTD. GRILLE

CONICAL TAKE-OFF

BALANCE DAMPER

RETURN AIR DUCT BOOT

ECCENTRIC REDUCER

CONCENTRIC REDUCER

VERTICAL FIRE DAMPER

HORIZONTAL FIRE DAMPER

VERTICAL SMOKE DAMPER

HORIZONTAL SMOKE DAMPER VERTICAL FIRE / SMOKE DAMPER

PROVIDED & WIRED BY E.T.C.

ROOF MOUNTED EXHAUST FAN

UNIT HEATER

---- DEMOLITION

CEILING EXHAUST FAN

HORIZONTAL FIRE / SMOKE DAMPER

DUCT SMOKE DETECTOR, INSTALLED BY M.T.C.,

HEATING, VENTILATION, & AIR CONDITIONING HWP HEATING WATER PUMP **HEAT EXCHANGER**

CUH

DN

GENERAL HVAC NOTES

- 1. NOTIFY OWNER OF ANY PIPING OR DUCTWORK DEMOLITION
- 2. FIELD VERIFY LOCATIONS OF EXISTING PIPING THAT MAY CONFLICT WITH NEW CONSTRUCTION AND RELOCATE AS
- 3. CONTRACTOR SHALL COORDINATE ALL WORK WITH OTHER
- 4. THE CONTRACTOR SHALL FIELD VERIFY THE SIZES, LOCATION, ELEVATIONS, AND DETAILS OF ALL EXISTING CONDITIONS THAT
- CONTRACTORS AND SUBCONTRACTORS AS REQUIRED BY LAW.
- ALL WORK SHALL CONFORM TO MICHIGAN MECHANICAL CODE, LATEST APPLICABLE EDITION.
- 9. ALL CONDENSATE DRAIN PIPING TO TERMINATE TO DRAIN VIA
- 10. IF THERE IS CONFLICTING INFORMATION IN THE PLANS OR SPECIFICATIONS THE MORE STRINGENT AND GREATER COST ITEM SHALL BE USED.
- 11. DRAWINGS INDICATE REQUIRED SIZES AND POINTS OF TERMINATION OF PIPES AND DUCTS AND SUGGESTED ROUTES. IT IS NOT INTENTION OF DRAWINGS TO INDICATE ALL NECESSARY OFFSETS. INSTALL WORK IN MANNER TO CONFORM TO STRUCTURE, AVOID OBSTRUCTIONS, PRESERVE HEADROOM AND KEEP OPENINGS AND PASSAGEWAYS CLEAR. DO NOT SCALE FROM DRAWINGS.

—— HPS —— HIGH PRESSURE STEAM (76 LBS. & ABV.)

— — SC — — STEAM CONDENSATE (GRAVITY)

— SC (BF) — STEAM CONDENSATE BOILER FEED

—— SA —— SUPPLY AIR DUCT

RA RETURN AIR DUCT

OA OUTSIDE AIR DUCT

EXHAUST AIR DUCT

— X-SA — EXIST SUPPLY AIR DUCT

— X-RA — EXIST RETURN AIR DUCT

— X-OA — EXIST OUTSIDE AIR DUCT

---- X-EA ---- EXIST EXHAUST AIR DUCT


HVAC PIPING

- THAT MAY AFFECT NORMAL OPERATION OF OTHER AREAS.
- DISCIPLINES PRIOR TO CONSTRUCTION TO AVOID CONFLICTS.
- MAY AFFECT THE WORK.
- 5. THE CONTRACTOR SHALL BE RESPONSIBLE FOR MAINTAINING THE INTEGRITY OF ALL EQUIPMENT AND MATERIALS IN A "NEW" CONDITION DURING CONSTRUCTION.
- 6. ALL WORK SHALL BE PERFORMED BY LICENSED
- 8. ALL CONDENSATE DRAIN PIPING SET @ MIN. 1% SLOPE.

UNISTRUT (TYP.) - HEF-T-FOOT ROOF BLOCK 15.7" X-ROOF W/ 1.6" x 8" UNISTRUT

SIDE VIEW

1-1/2" x 1-1/2" —

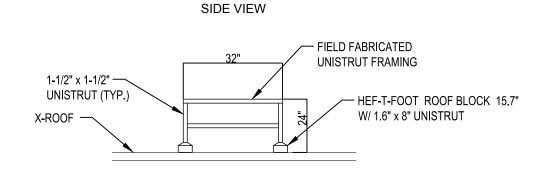

CONDENSING UNIT SUPPORT FRAME DIAGRAM

HVAC PIPING VALVES

---- CWS ---- CHILLED WATER SUPPLY ——

GATE VALVE — CWR — CHILLED WATER RETURN ——₩—— GAS COCK — CHECK VALVE —— CD —— CONDENSATE DRAIN ----- CTS ---- CONDENSER WATER SUPPLY ——→⊗⊢—— BALANCE COCK —— CTR —— CONDENSER WATER RETURN ——I⊗⊢—— CIRCUIT SETTER ----- CS ----- COOLING TOWER WATER SUPPLY TWO-WAY CONTROL VALVE THREE-WAY CONTROL VALVE —— DX —— DIRECT EXPANSION —— CLOBE VALVE BALL VALVE ———— EXPANSION VALVE WITH THERMOSTATIC BULB ——I♥I—— PLUG VALVE ——IO——— BUTTERFLY VALVE ——L—— LIQUID (REFRIGERANT) RELIEF VALVE —— DXS —— SUCTION (DIRECT EXPANSION) HOSE & DRAIN END VALVE —— DXL —— LIQUID (DIRECT EXPANSION) PRESSURE RELIEF VALVE LPS — LOW PRESSURE STEAM (0-20 LBS.) PRESSURE REDUCING VALVE

HVAC DUCTWORK TEMPERATURE CONTROL SYMBOLS

THERMOSTAT PROGRAMMABLE THERMOSTAT THERMOSTAT (W/ NIGHT SETBACK) ROOM SENSOR HUMIDISTAT PRESSURE GAUGE

> DAMPER (ELECTRIC OPERATION) DAMPER (PNEUMATIC OPERATION) /\ /\ DAMPER BLADES

TRIPLE DUTY VALVE

STRAINER (BLOW-OFF)

——— GAS PRESSURE REGULATOR

HVAC PIPING SYMBOLS

FLOW DIRECTION → PIPING DROP INLINE PIPING DROP ——,[‡], PIPING TEE t+---- PIPING ELBOW THERMOMETER —|**(**)}|— PUMP ——I—— UNION PIPE ANCHOR ———— PIPE GUIDE BACK FLOW PREVENTER ————] PIPE CAP PIPE BREAK THERMOMETER WELL _____EXPANSION LOOP EXPANSION COMPENSATOR FT FLOAT & THERMOSTATIC STEAM TRAP

BT INVERTED BUCKET STEAM TRAP

CASSETTE AIR CONDITIONING SCHEDULE										
TAG	SERVICE	MODEL	SUPPLY	TC		COMMENTS				
IAG	SERVICE	MODEL	CFM	(BTUH)	MCA	VOLTAGE	PHASE	COMMENTS		
AC-1	ELEVATOR EQUIP ROOM	PLA-A12EA7	400	12,000	1	208	1	1,2,3,4,5,6		
NOTES:										
. BASED ON N	MITSUBISHI ELEC					RICATED UNISTRU		CONDENSING UNIT		

6. DISCONNECT BY MANUFACTURER

			CONI	DENSI	NG UNIT	SCHE	DULE				
			CAPACITY								
TAG	SERVES	MODEL	MBH	EER	VOLTAGE	PHASE	MCA	DISC. BY	STARTER BY	COMMENTS	
CU-1	ELEVATOR EQUIP. ROOM	PUY-A12NKA7	12	16.4	230	1	11	EC	EC	1,2,3	
NOTES: 1. BASED ON	MITSUBISHI ELEC	TRIC			ELECTRICAL	NOTES:					
2. CONCRETI	E PAD BY MC				EC - ELECTRICAL CONTRACTOR						
3. LOW AMBIE	ENT FOR 0 DEG F	AMBIENT TEMP.			MC - MECHA	NICAL CONTRA	CTOR				
					NR - NOT RE	QUIRED					

3. COOLING DESIGN BASED ON 80°F DB AND 67°F WB, 50% RH



08/18/2023 08/25/2022 DATE ISSUED STS DRAWN BY

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MSP NORTHVILLE LAB **ELEVATOR** REPLACEMENT

42145 W SEVEN MILE RD.,

NORTHVILLE, MI 48167 PROJECT



LERCH BATES 950 Boston Street SE Grand Rapids MI 49507 CONSULTANT

MECHANICAL SYMBOLS, ABBREV, NOTES, SCHEDULES


SHEET TITLE

22300


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MSP NORTHVILLE LAB ELEVATOR REPLACEMENT

42145 W SEVEN MILE RD., NORTHVILLE, MI 48167

PROJECT

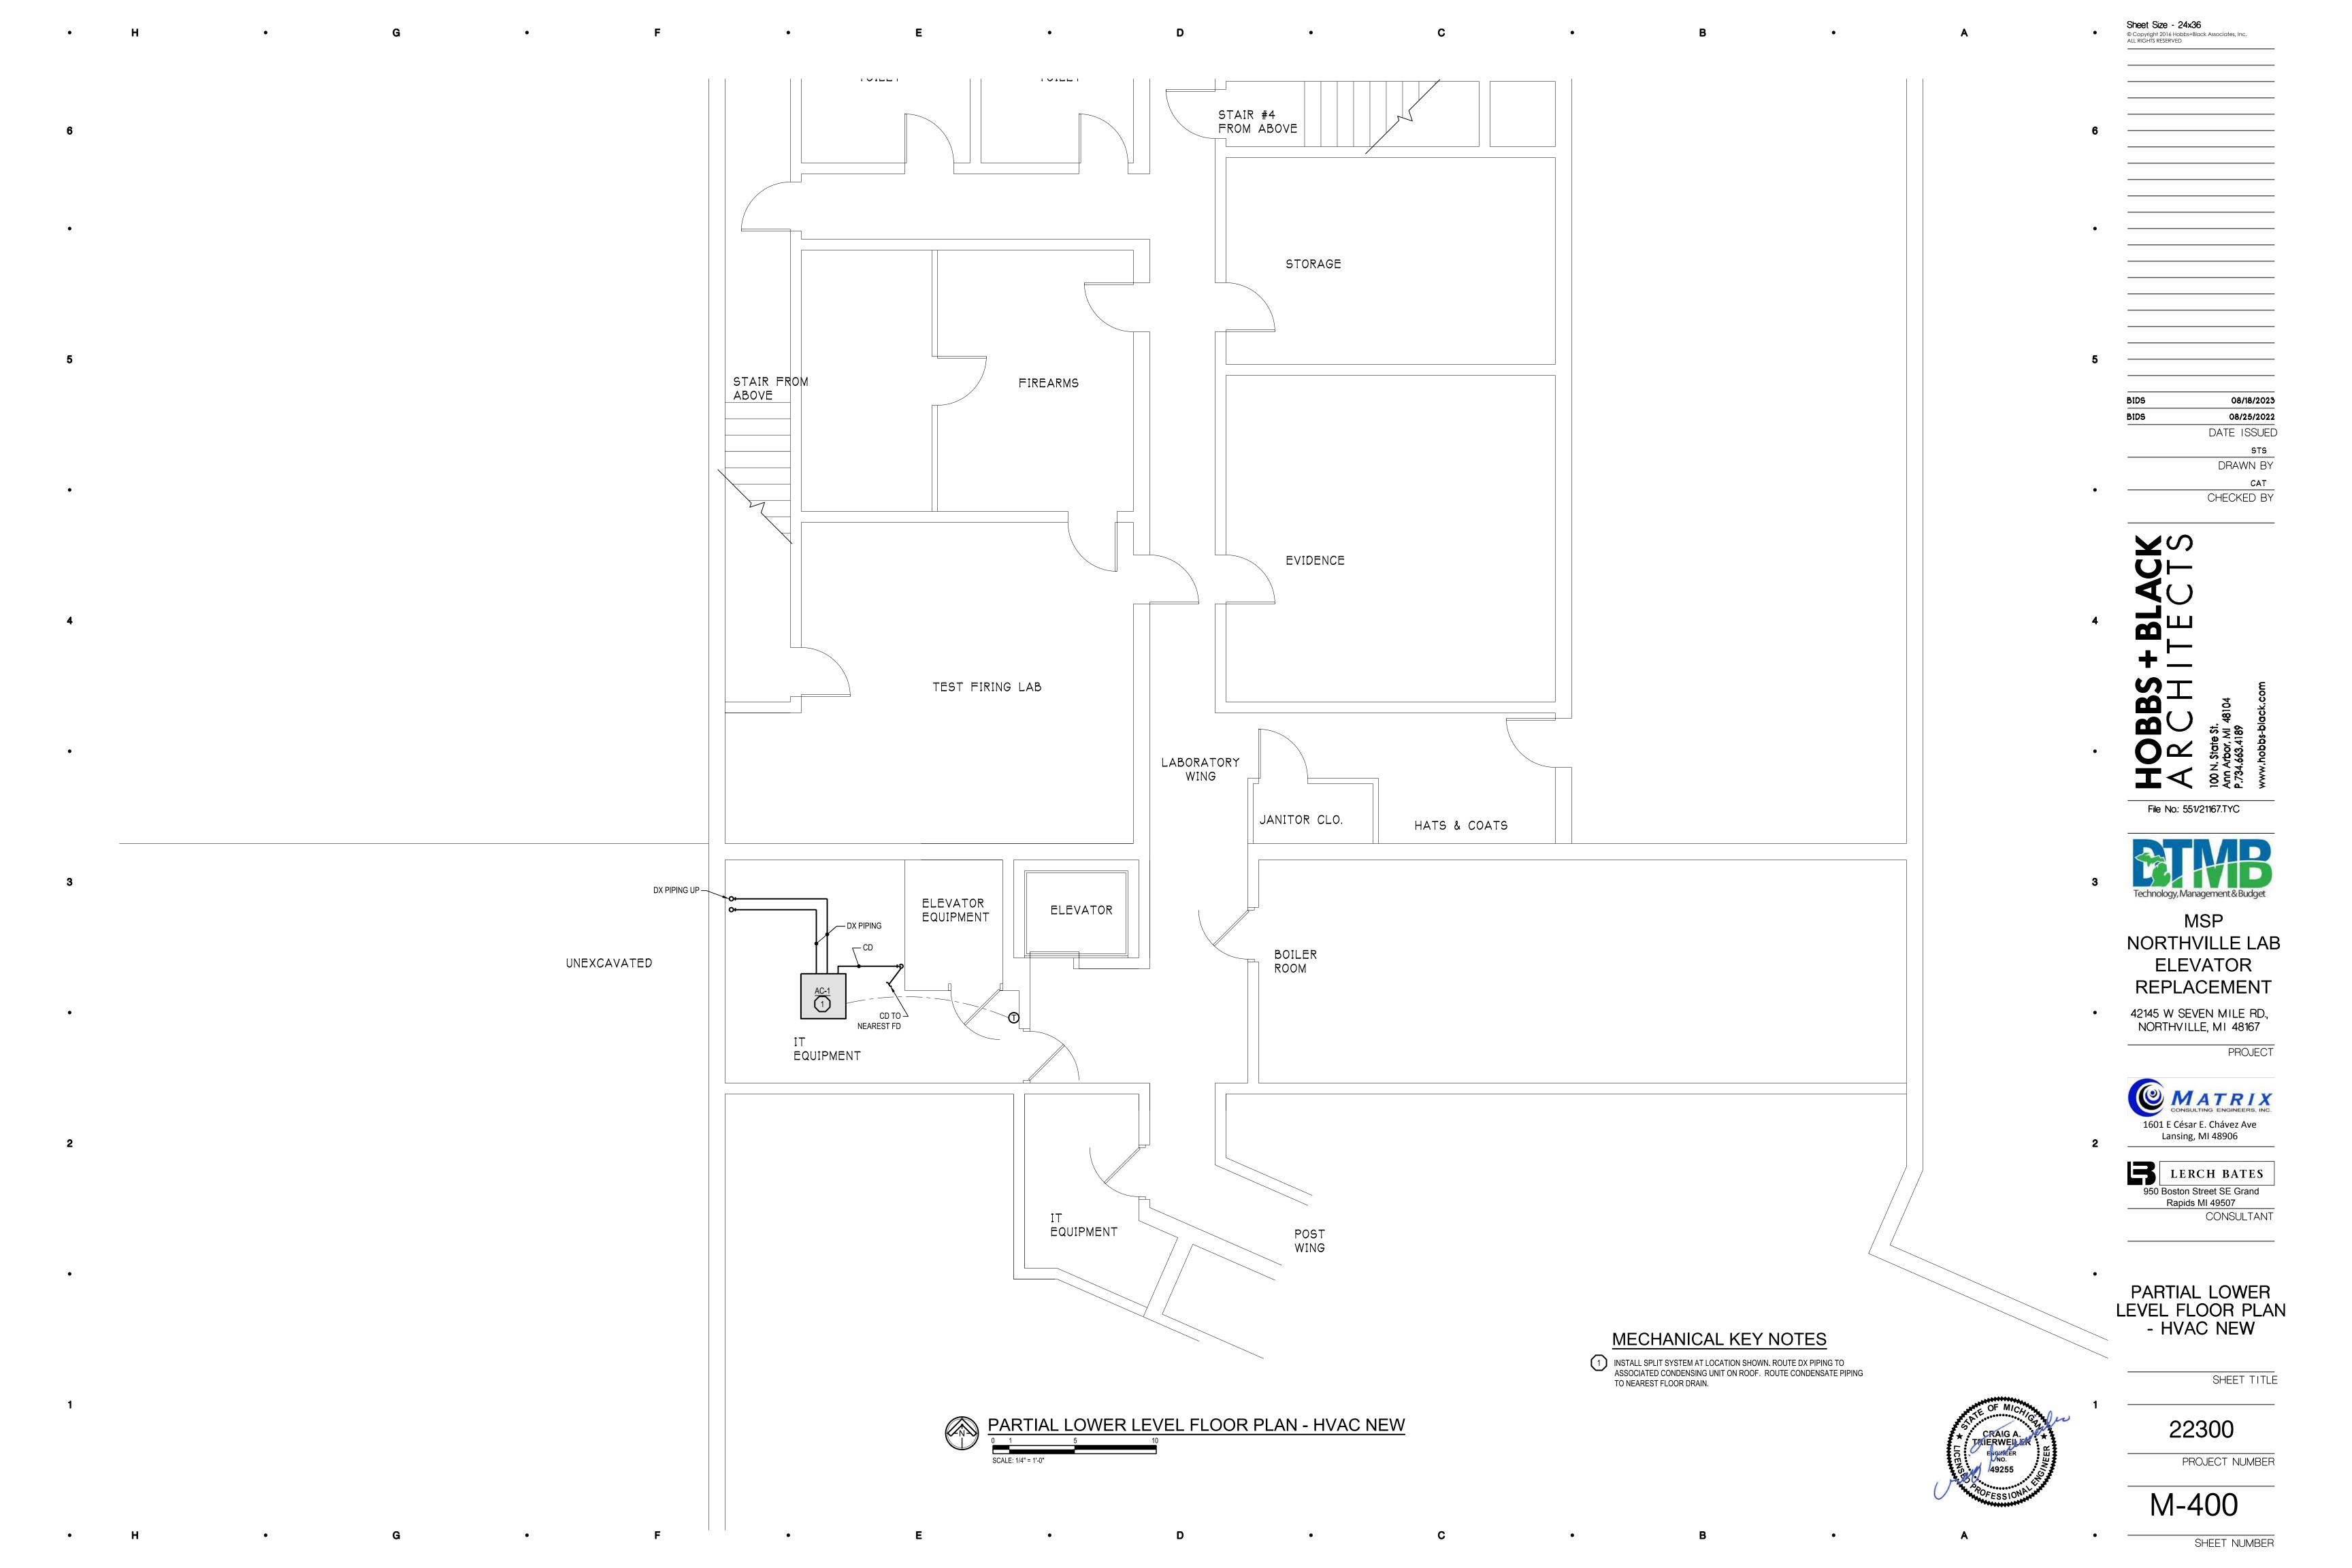

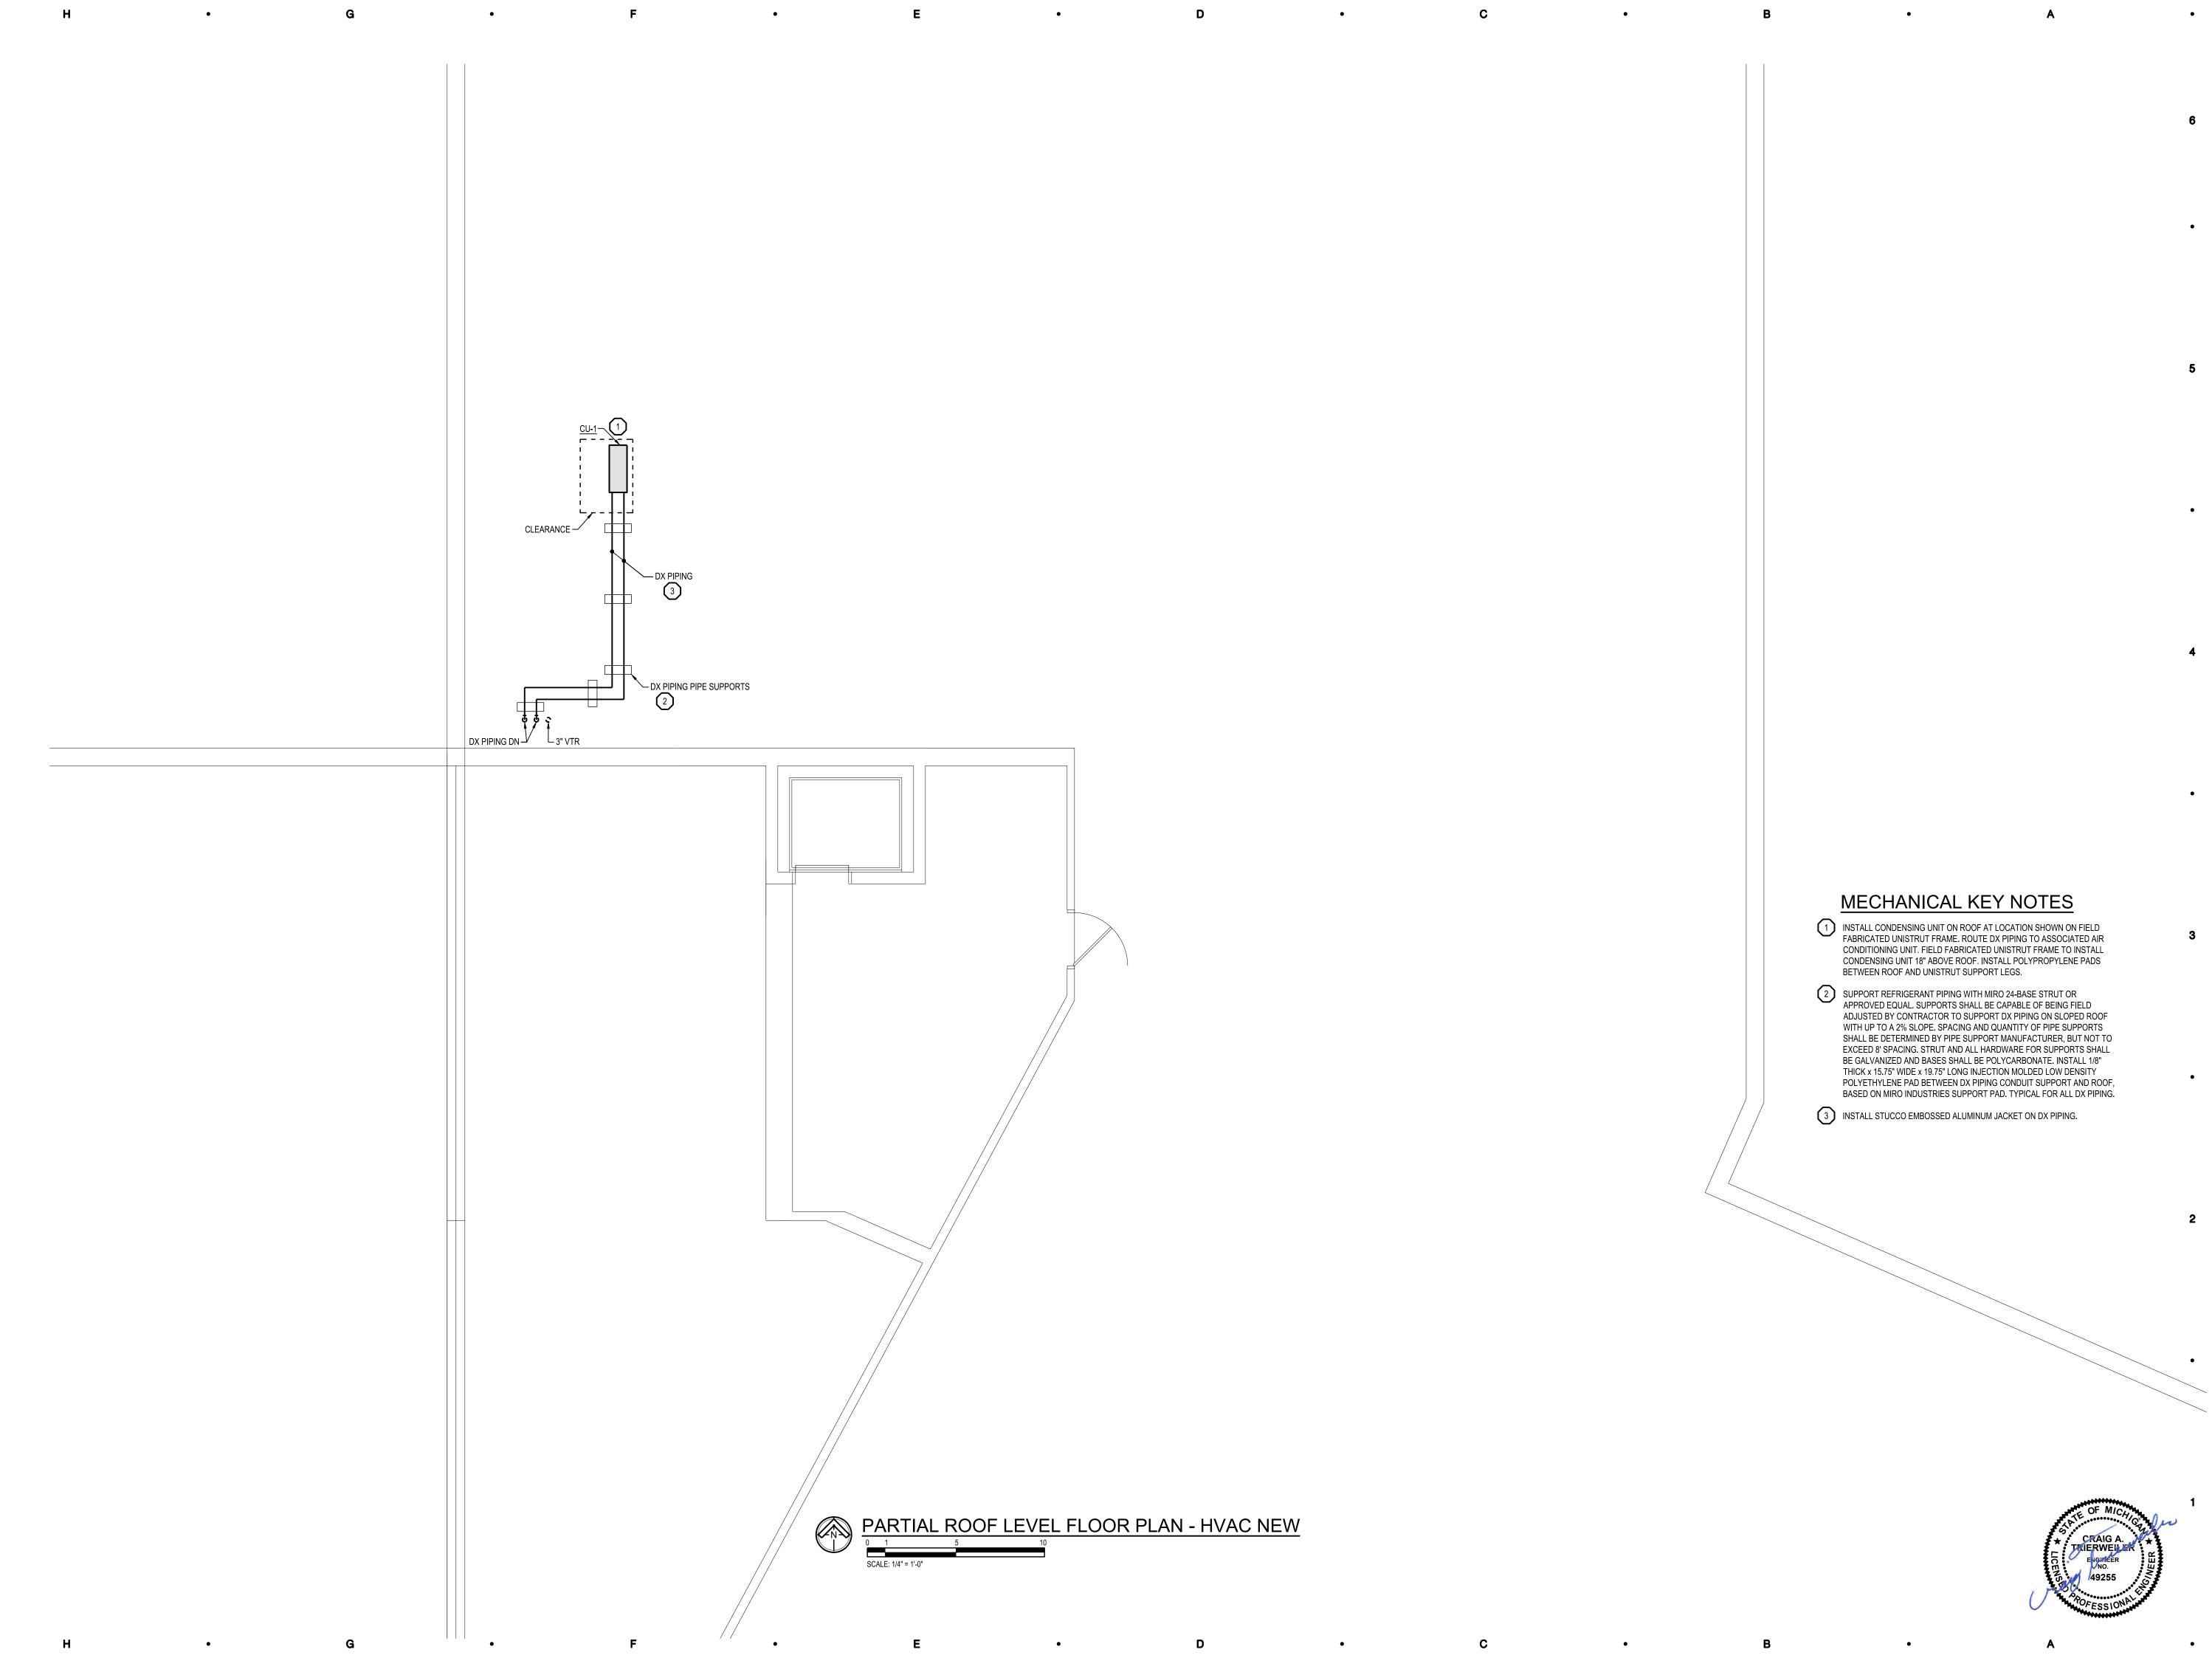

PARTIAL ROOF LEVEL FLOOR PLAN - HVAC NEW

SHEET TITLE

22300

PROJECT NUMBER

M-402

PLUMBING ABBREVIATIONS

AREA DRAIN NOT TO SCALE AUTOMATIC SPRINKLER RISER ORD OVERFLOW ROOF DRAIN ASR BFS BELOW FLOOR SLAB OXY OXYGEN BACK WATER VALVE PUMP CATCH BASIN PRESSURE DROP CB CAST IRON POLY-VINYL-CHLORIDE **CLEAN OUT** RAIN CONDUCTOR CONTROL VALVE ROOF DRAIN DRINKING FOUNTAIN ROUGH-IN DIA DIAMETER REQ'D REQUIRED DN DOWN SAN SANITARY DWH DOMESTIC WATER HEATER SHWR SHOWER ELECTRICAL TRADES CONTRACTOR SINK EWC ELECTRIC WATER COOLER STAND PIPE **EXIST EXISTING** SQ. FT. SQUARE FEET FLOOR DRAIN SERVICE SINK FINAL CONNECTIONS STORM S&W STOP & WASTE FDC FIRE DEPT. CONNECTION FINISH FLOOR STR STRAINER FIRE HOSE VALVE STACKED VENT TYP. TYPICAL FEET GAL GALLON URINAL GD GARBAGE DISPOSAL VACUUM BREAKER GREASE INTERCEPTOR VENT STACK VARIABLE FREQUENCY DRIVE GPH GALLONS PER HOUR V.F.D VENT THRU ROOF VTR GPM GALLONS PER MINUTE HOSE BIB WASTE HEAD (FT) WET BULB HORSE POWER WATER CLOSET INSIDE DIAMETER WALL HYDRANT INVERT ELEVATION WASTE STACK LAVATORY WASTE AND VENT LAUNDRY TRAY EXIST. CW PIPING MEDICAL AIR — ITEM MAX MAXIMUM — EXISTING MGC MEDICAL GAS CONSOLE MH MAN HOLE MIN MINIMUM MOP SINK

GENERAL PLUMBING NOTES

1. ALL PLUMBING WORK SHALL CONFORM TO MICHIGAN PLUMBING CODE, LATEST APPLICABLE EDITION.

2. INSTALL ALL EQUIPMENT, MATERIALS, AND ACCESSORIES PER MANUFACTURERS WRITTEN INSTRUCTIONS.

3. ALL PIPE SIZES SHOWN ARE SERVICE SIZE. SIZE SLEEVES FOR 1" CLEAR SPACE BETWEEN PIPE AND SLEEVE FOR INSTALLATION OF MECHANICAL SEAL.

4. CONTRACTOR TO VERIFY LOCATIONS OF EXISTING UNDERGROUND UTILITIES BEFORE BEGINNING WORK.

5. CONTRACTOR SHALL DEMOLISH & REMOVE EXISTING PIPING, FITTINGS, & EQUIPMENT AS REQUIRED FOR NEW INSTALLATIONS. VALVE & CAP PIPING TO REMAIN.

6. FIELD VERIFY LOCATIONS OF EXISTING PIPING THAT MAY CONFLICT WITH NEW CONSTRUCTION AND RELOCATE AS NEEDED.

7. NOTIFY OWNER OF ANY PIPING DEMOLITION THAT MAY AFFECT NORMAL OPERATION OF OTHER AREAS.

8. MECHANICAL SEALS REQUIRED FOR BELOW GRADE WALL PENETRATIONS.

9. ALL FLOOR SINKS TO BE EQUIPPED WITH TRAP PRIMERS OR TRAP SEAL DEVICES, UNLESS OTHERWISE NOTED.

10. 1% SLOPE FOR ALL SANITARY PIPING.

11. THE CONTRACTOR SHALL FIELD VERIFY THE SIZES, LOCATION, ELEVATIONS, AND DETAILS OF ALL EXISTING CONDITIONS THAT MAY AFFECT THE WORK.

12. THE CONTRACTOR SHALL BE RESPONSIBLE FOR MAINTAINING THE INTEGRITY OF ALL EQUIPMENT AND MATERIALS IN A "NEW" CONDITION DURING CONSTRUCTION.

13. ALL WORK SHALL BE PERFORMED BY LICENSED CONTRACTORS AND SUBCONTRACTORS AS REQUIRED BY LAW.

14. DESIGN AND CONSTRUCTION SHALL BE IN ACCORDANCE WITH THE CODES AND REGULATIONS ENFORCED BY LOCAL BUILDING OFFICIALS.

15. IF THERE IS CONFLICTING INFORMATION IN THE PLANS OR SPECIFICATIONS THE MORE STRINGENT AND GREATER COST ITEM SHALL BE USED.

PLUMBING VALVES

───── GATE VALVE ——

→ GAS COCK

────── CHECK VALVE

——⊸⇔——— BALANCE COCK

——**>** BALL VALVE

——-
→ OS&Y VALVE

——i∱⊢—— PLUG VALVE

——₩—— SOLENOID VALVE

——d⊢— BUTTERFLY VALVE

HOSE & DRAIN END VALVE

PRESSURE RELIEF VALVE

——── TRIPLE DUTY VALVE

STRAINER (BLOW-OFF)

PRESSURE REDUCING VALVE

———— GAS PRESSURE REGULATOR

RELIEF VALVE

────────── TWO-WAY CONTROL VALVE THREE-WAY CONTROL VALVE

——————— EXPANSION VALVE WITH THERMOSTATIC BULB

16. DRAWINGS INDICATE REQUIRED SIZES AND POINTS OF TERMINATION OF PIPES AND SUGGESTED ROUTES. IT IS NOT INTENTION OF DRAWINGS TO INDICATE ALL NECESSARY OFFSETS. INSTALL WORK IN MANNER TO CONFORM TO STRUCTURE, AVOID OBSTRUCTIONS, PRESERVE HEADROOM AND KEEP OPENINGS AND PASSAGEWAYS CLEAR. DO NOT SCALE FROM DRAWINGS.

SUMP PUMP SCHEDULE **ELECTRICAL** DISCHARGE FT. GPM MODEL TYPE COMMENTS HEAD PIPE | SOLID | TYPE DIA DEPTH HP VOLTS PHASE RPM EXISTING EXISTING EXISTING SP-1 1413 SIMPLEX 50 0.5" 120 1750 1,2,3 25 2"

NOTES:

1. BASED ON: WEIL

PROVIDE CONTROL PANEL W/ INTERNAL DISCONNECT & STARTER 3. PROVIDE LEVEL CONTROL SYSTEM WITH HIGH LEVEL ALARM STROBE LIGHT

ABBREVIATIONS: PCC = PRE-CAST CONCRETE

TAC	MODEL	LOCATION	OIL HOLDING	GPM	INLET/	D	CONTRACTIC		
TAG	MODEL	LOCATION	CAPACITY (LBS)		OUTLET	WIDTH	DEPTH	HEIGHT	COMMENTS
OI-1	5400	STORAGE RM 156	82	50	4"	34	24	34	1,2

	PLUMBING FIXTURE SCHEDULE										
TAG	FIXTURE	ROUGI CW	H-IN CON	NECTIC SAN	N SIZE VENT	FAUCET TYPE	FIXTURE SIZE	ACCESSORIES AND COMMENTS			
HD-1	HUB DRAIN	-	-	-	-	-	12 x 12 TOP	SEE PLAN FOR SANITARY SIZE, 3/4" TOP GRATE			

PLUMBING SYMBOLS LEGEND

MEDICAL AIR

---- DEMOLITION

MECHANICAL TRADES CONTRACTOR

PLUMBING PIPIN	IG	PLUMBING	G EQUIPMENT
— cw ———	COLD WATER		FLOW DIRECTION
cw	COLD WATER BELOW FINISH SLAB	c+	PIPING DROP
— HW ————	HOT WATER	——ю	PIPING RISE
HW	HOT WATER BELOW FINISH SLAB		FLOOR CLEANOUT
— HWR ————	HOT WATER RETURN		INLINE PIPING DROP
HWR	HOT WATER RETURN BELOW FINISH SLAB		INLINE PIPING RISE
— SW ———	SOFTENED WATER	, †,	PIPING TEE
SW	SOFTENED WATER BELOW FINISH SLAB	t,	PIPING ELBOW
— SWR ———	SOFTENED WATER RETURN		INLINE CLEANOUT
SWR	SOFTENED WATER RETURN BELOW FINISH SLAB		PLUMBING TRAP
— TW ————	TEMPERED WATER	Q	THERMOMETER
TW	TEMPERED WATER BELOW FINISH SLAB		CONNECTION
— TWR ————	TEMPERED WATER RETURN	——————————————————————————————————————	PUMP
TWR	TEMPERED WATER RETURN BELOW FINISH	——-II	UNION
	SLAB		PIPE ANCHOR
— DI ———	DEIONIZED WATER		PIPE GUIDE
DI	DEIONIZED WATER BELOW FINISH SLAB	0	FLOOR DRAIN & FLOOR SINK
— RO ————	REVERSE OSMOSIS WATER RETURN RELIGIA		BACK FLOW PREVENTER
RO	REVERSE OSMOSIS WATER RETURN BELOW FINISH SLAB	 II	FLANGE END CONNECTION
— FP ———	FIRE PROTECTION	—+ ∕5	WALL HYDRANT & HOSE BIBB
— G ———	GAS (NATURAL)	Ö,	REGULAR & OVERFLOW ROOF DRAIN
— LP ———	GAS (LIQUID PETROLEUM)		PIPE CAP
— ARV ———	ACID RESISTANT	——(M)——	PIPE BREAK
— ARW ————	VENT ACID RESISTANT WASTE	M	WATER METER GAS METER
— ARW — — —	ACID RESISTANT WASTE BELOW FINISH SLAB	——————————————————————————————————————	PRESSURE GAUGE
— RC ———	RAIN CONDUCTOR	——————————————————————————————————————	FIRE HYDRANT
— ST — — —	STORM BELOW FINISH SLAB	•	SPRINKLER HEAD (PENDANT)
— ORC ———	OVERFLOW RAIN CONDUCTOR	φ	SPRINKLER HEAD (UPRIGHT)
— ORC — — —	OVERFLOW RAIN CONDUCTOR BELOW FINISH SLAB		SPRINKLER HEAD (SIDEWALL)
— SAN ———	SANITARY WASTE	─	FIRE DEPARTMENT CONNECTION
— SAN — — —	SANITARY WASTE BELOW FINISH SLAB		PIPING FLEXIBLE CONNECTOR
- V	VENT PIPING		SIGHT GLASS
V	VENT PIPING BELOW FINISH SLAB		PIPE EXPANSION
— CA ———	COMPRESSED AIR	——————————————————————————————————————	COMPENSATOR FLOW SENSOR DEVICE
 02	OXYGEN		FLOW METER
— NO ———	NITROUS OXIDE	FS	FLOW SWITCH
— N2 ———	NITROGEN	PS	PRESSURE SWITCH

——|ss|—— supervisory switch inverted

FT FLOAT & THERMOSTATIC TRAP

BT BUCKET TRAP

MISCELLANEOUS NOTES


POINT OF CONNECTION BETWEEN NEW AND POINT OF EXISTING TO REMAIN AND EXISTING

INDICATES PLAN NOTE

INDICATES DEMOLITION NOTE

DETAIL BUBBLE XX DETAIL NUMBER XXXX PAGE LOCATION INDICATES

DIRECTION OF DETAIL SECTION

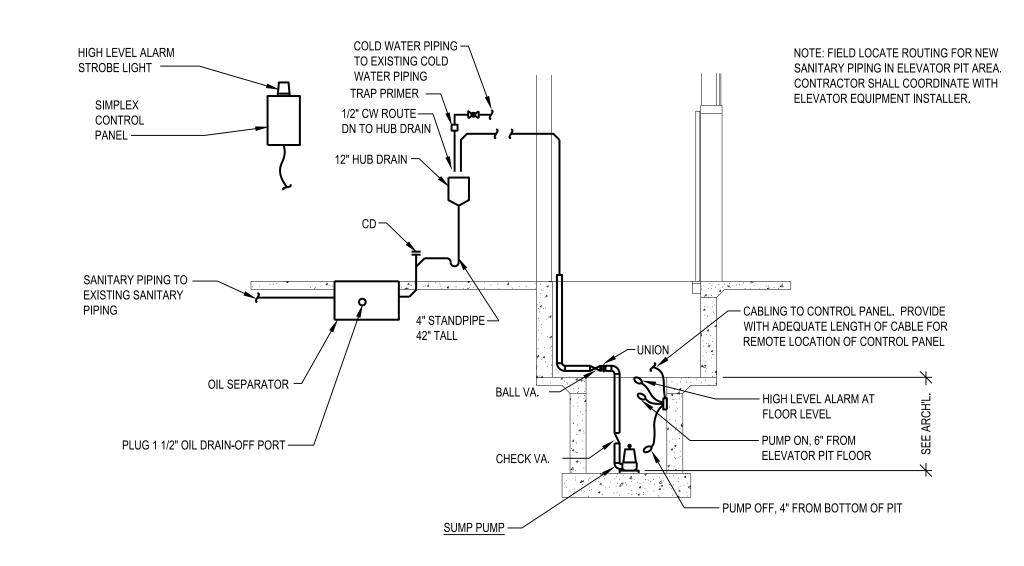

ELEVATOR PUMPING SYSTEM DETAIL

SCALE: NTS

08/18/2023 08/25/2022 DATE ISSUED

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MSP NORTHVILLE LAB **ELEVATOR** REPLACEMENT

42145 W SEVEN MILE RD., NORTHVILLE, MI 48167

PROJECT



LERCH BATES 950 Boston Street SE Grand Rapids MI 49507 CONSULTANT

PLUMBING SYMBOLS, ABBREV, NOTES, SCHEDULES


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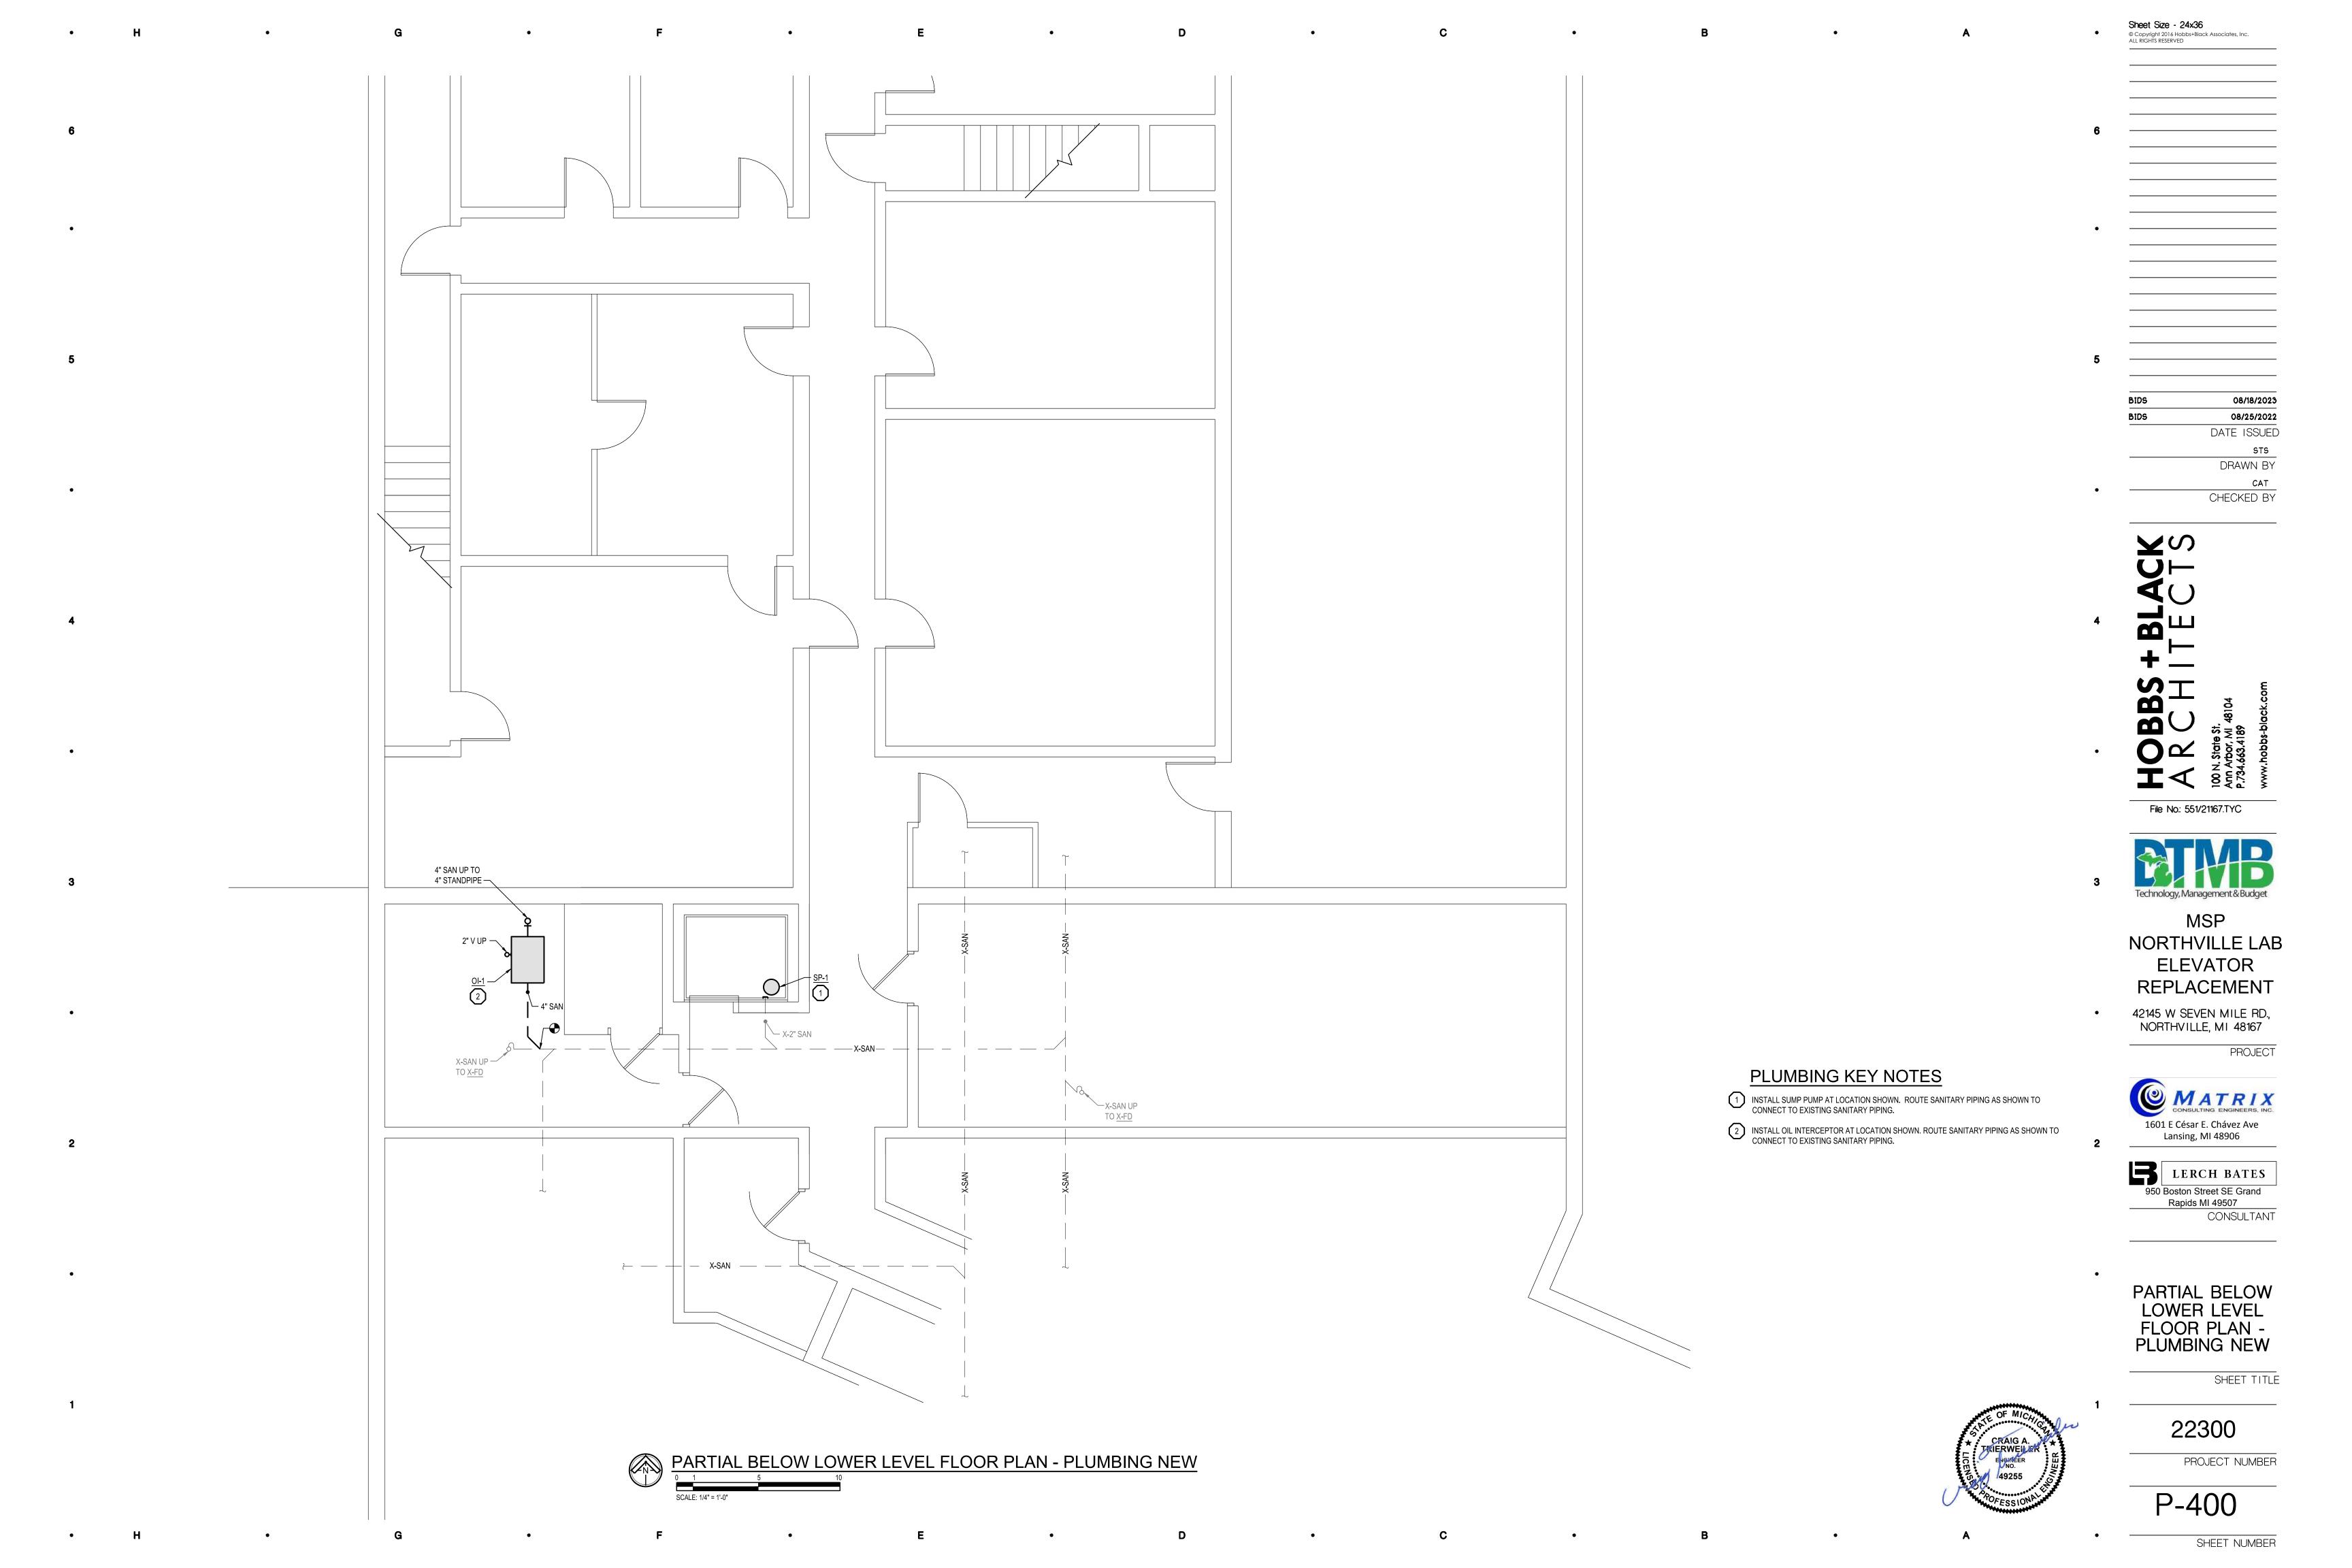
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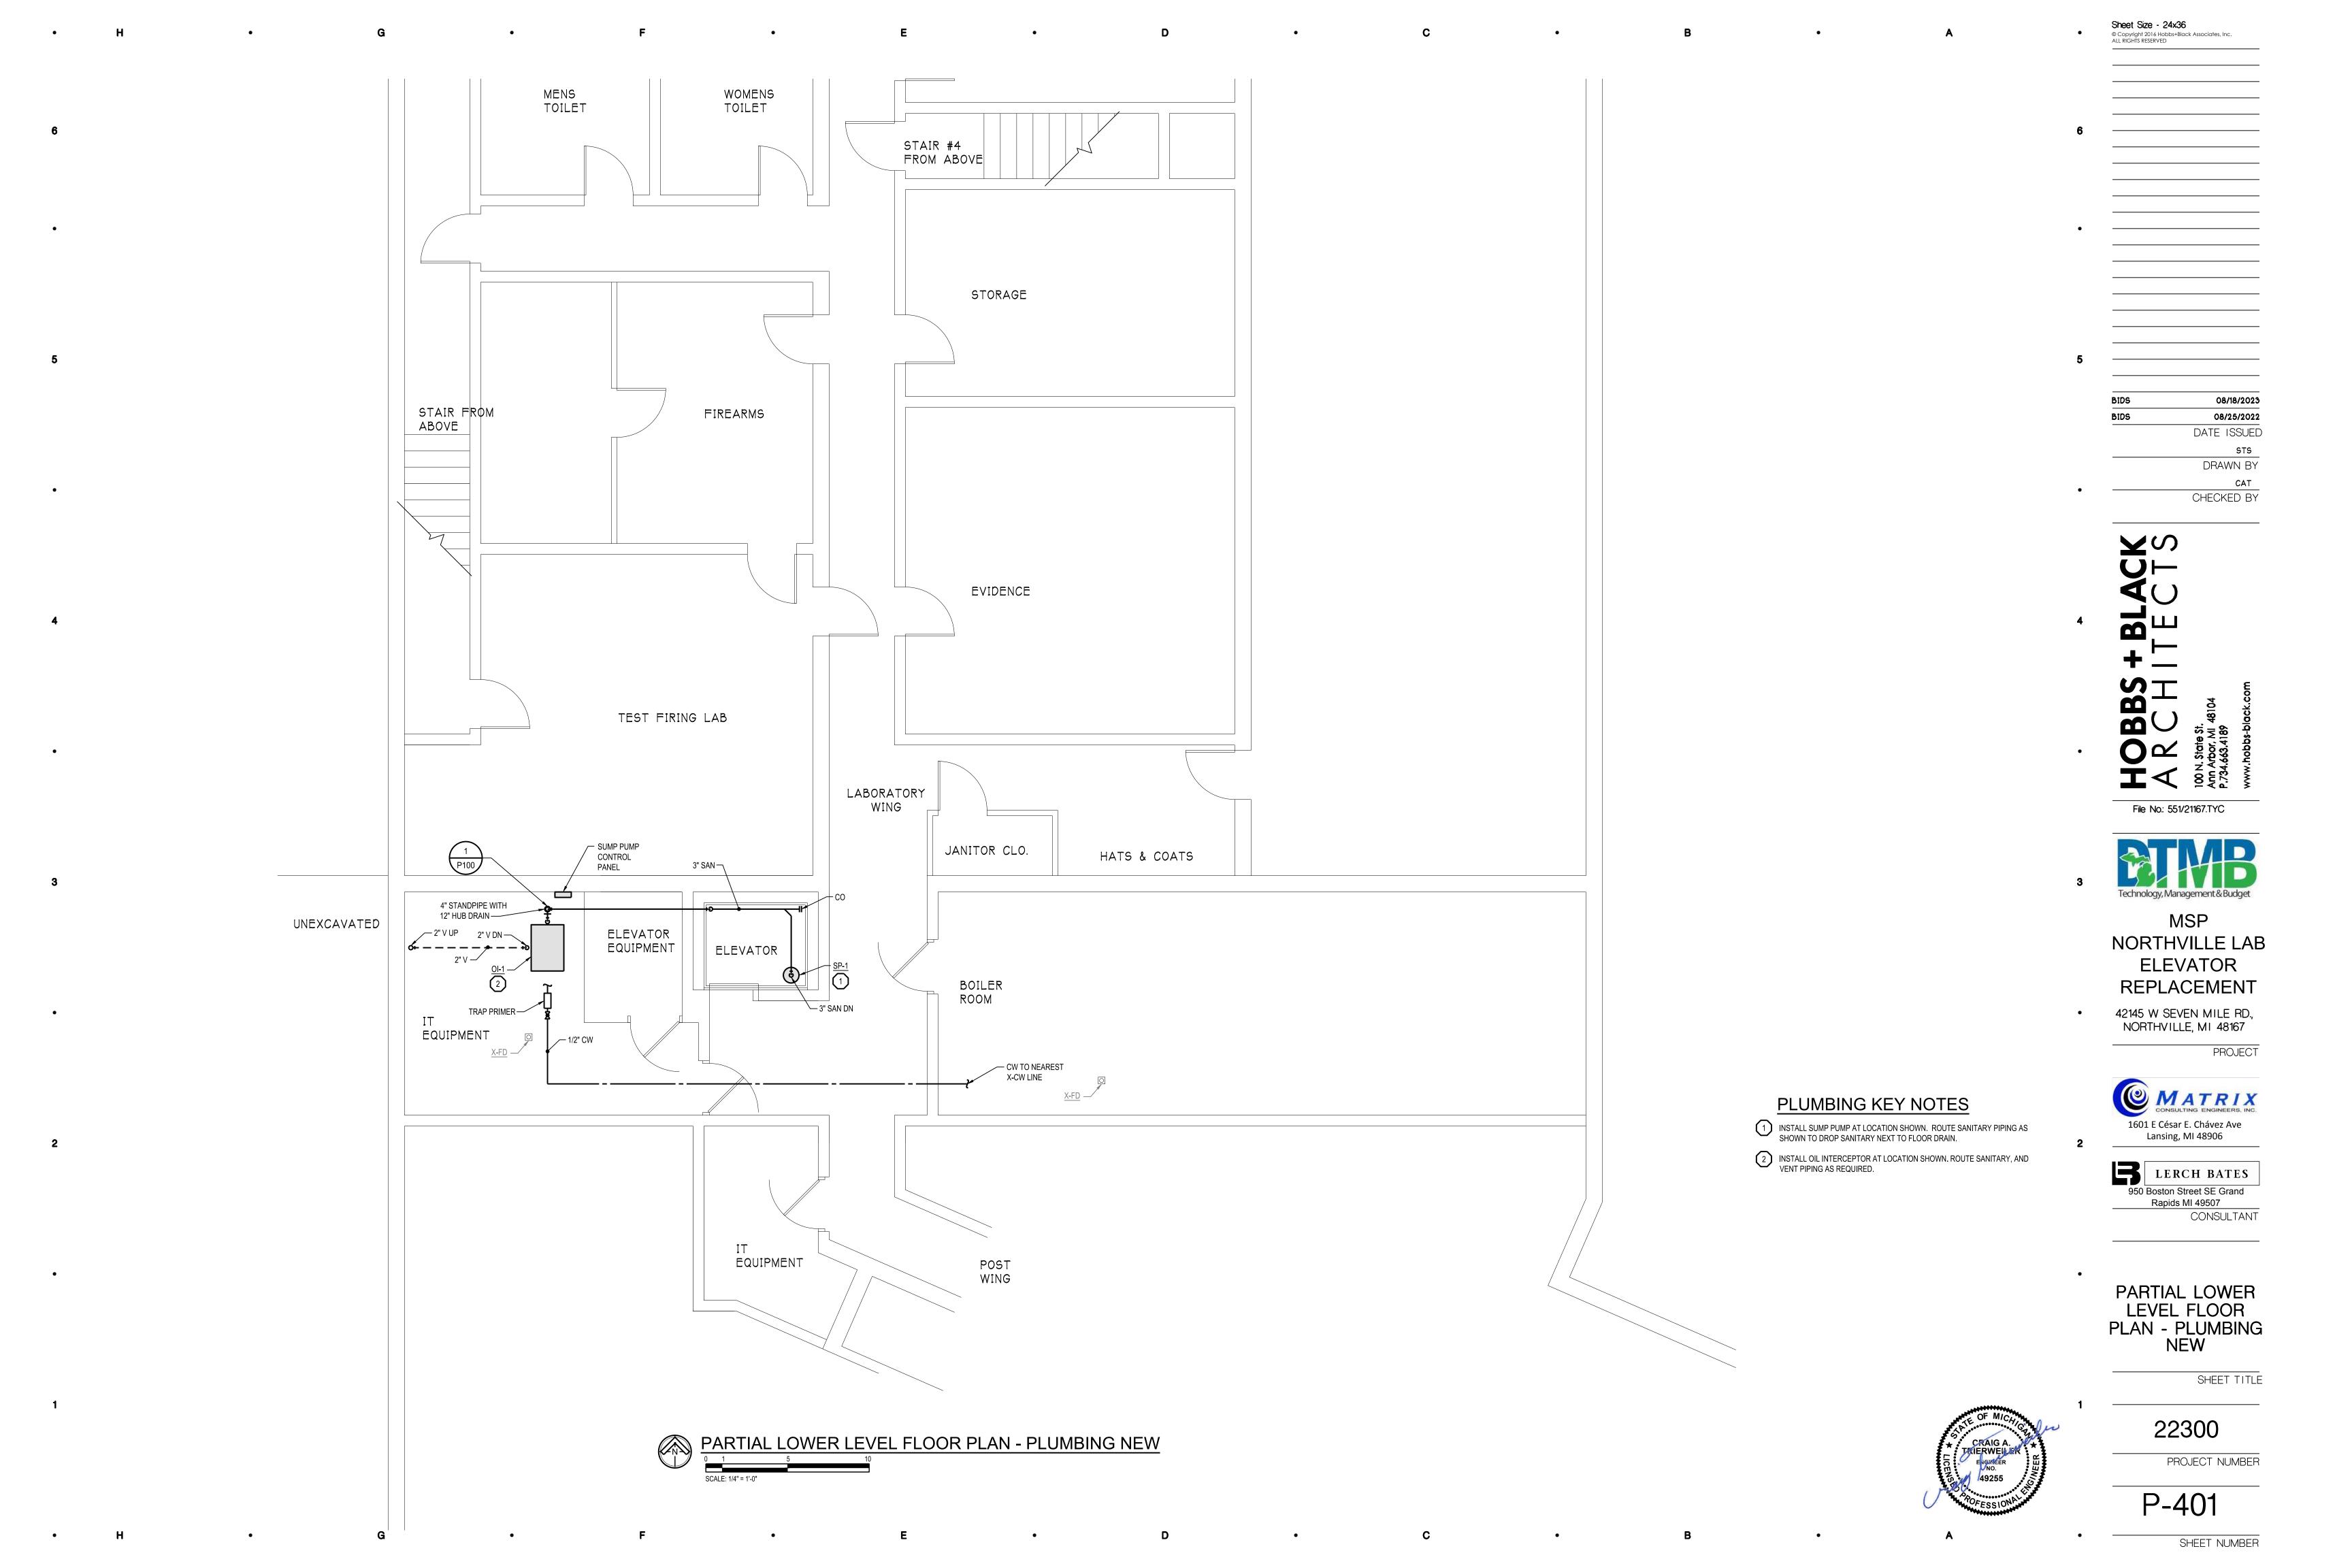
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ELECTRICAL SYMBOLS LEGEND

		ELECI	RICAL SYMBOLS LEG	PEND	<u>-</u>
	OUTLETS		FIXTURES		SERVICE and EQUIPMENT
b	SINGLE RECEPTACLE (120 VOLT)	О	LIGHT FIXTURE	TVSS	TRANSIENT VOLTAGE SURGE SUPPRESSION
₽ Њ	DUPLEX RECEPTACLE	<u>□</u>	STRIP FIXTURE	VFD	VARIABLE FREQUENCY DRIVE
b	EMERGENCY RECEPTACLE		EMERGENCY LIGHT FIXTURE		TRANSFORMER
₽	DOUBLE DUPLEX RECEPTACLE	-	IN-GRADE LIGHT FIXTURE		DISCONNECT SWITCH
oF	FLUSH FLOOR BOX	Od	SPOTLIGHT (number of heads shown)		MAGNETIC STARTER
)S	SURFACE FLOOR BOX	③	EXIT SIGN (face & direction as shown)	\(\overline{\text{\tin}\exitt{\text{\tin}\text{\texi\text{\texi}\text{\text{\text{\text{\text{\text{\text{\text{\text{\texi}\text{\text{\texi}\text{\text{\text{\text{\text{\text{\texi}\text{\text{\texi}\text{\t	COMB. STARTER
①	SPECIAL EQUIPMENT RECEPTACLE	φ	WALL MOUNT LIGHT FIXTURE		PANELBOARD, SURFACE MOUNTED
▼	TELEPHONE OUTLET	+	CEILING LIGHT FIXTURE	<u> </u>	PANELBOARD, FLUSH MOUNTED
abla	DATA OUTLET	<u>\\ \\ \\ \\ \\ \\ \\ \\ \\ \\ \\ \\ \\ </u>	TRACK & FIXTURE STREET TYPE POLE FIXTURE		WEATHERHEAD
•	TELEPHONE / DATA OUTLET	⊶ □	POLE MOUNTED LIGHT FIXTURE	D	UTILITY METER, AS REQUIRED
■ _{PP}	POWER POLE		EXTERIOR WALL MOUNT LIGHT FIXTURE	O	DIGITAL EQUIPMENT METER, AS REQUIRED
J	JUNCTION BOX		WALLPACK LIGHT FIXTURE	CT	CURRENT TRANSFORMERS
J	WALL JUNCTION BOX	•	SPECIAL PURPOSE LIGHT FIXTURE	\@\	GENERATOR, KW SHOWN
J	PULL (JUNCTION) BOX		HIGH BAY LIGHT FIXTURE	<u> </u>	TELEPHONE TERMINAL BOARD
J	UNDERFLOOR JUNCTION BOX		EMERGENCY EGRESS LIGHT FIXTURE	Ī.	GROUND CONNECTION PER N.E.C.
<u>(</u> 2)	CEILING MOUNTED WIFI	Ľ,	(number of heads shown)	WW	WIREWAY
	SWITCHES	\nearrow	DOCK LIGHT FIXTURE	TS1	TRANSFER SWITCH
\$	SINGLE-POLE SWITCH		CIRCUITRY and RACEWAYS		ENCLOSED CIRCUIT BREAKER
Ψ \$3	THREE-WAY SWITCH		CONDUIT INSTALLED (by E.C.)	HE	CAPACITOR
\$4	FOUR-WAY SWITCH		CONDUIT INSTALLED (by others)		CONTROL
\$ _P	SWITCH WITH PILOT LIGHT		CONDUIT STUB UP	\bigcirc	THERMOSTAT
\$тп	THERMAL OVERLOAD SWITCH	•	CONDUIT STUB DOWN	$_{oldsymbol{eta}}$	HUMIDISTAT
\$м	MANUAL MOTOR SWITCH	 1,3	HOME RUN (with circuit numbers)	_	PHOTOCELL (voltage as required)
\$ _K	KEY SWITCH	——	END OF CONDUIT RUN	TC	TIME CLOCK (24 hour U.O.N.)
\$ _T	TIME SWITCH		END OF CONDUIT RUN, CAP AND STAKE	1 3	PUSHBUTTON STATION (number of
D	DIMMER SWITCH		"CONDUIT RUN CONTINUES" INDICATION		buttons indicated)
	MECHANICAL	_{OR}	FLEXIBLE PIGTAILS/CONNECTIONS		CONTROL TRANSFORMER
Ŋ	SINGLE PHASE MOTOR		WIREMOLD AS SPECIFIED		LIGHTING CONTACTOR
	THREE PHASE MOTOR	—PM—	PLUGMOLD AS SPECIFIED	IC	IRRIGATION CONTROLLER (120 volt xxVA connection by x/C)
// -	RESISTANCE HEATER, KW SHOWN	— BD —	BUS DUCT	•	ANTI COMMODICATION OF A COMMODITY AND A COMMOD
~~~	PIPE TRACE HEATER	—UFD—	UNDERFLOOR DUCT	(OS1)	WALL MOUNT DUAL TECHNOLOGY SENSOR
⊘ੋ→	ELECTRIC UNIT HEATER		SOUND and SIGNAL	$\stackrel{\smile}{\Phi}$	
VH)	ELECTRIC WATER HEATER	S	SPEAKER	OS2	OCCUPANCY SENSOR / PHOTOCELL
	NURSE CALL	© ⊗₁	WALL MOUNTED SPEAKER	∀	
CC	NURSE CALL CONTROLLER	₩.	WALL MOUNTED SPEAKER / CLOCK COME	3O (os3)	ULTRASONIC SENSOR - 360° - 2 CIRCUIT
<u>v</u>	MASTER STATION		SINGLE FACE CLOCK	\bigvee	DETRICON GOOD ZONGON
<u>"</u>]	EMERGENCY PULL STATION	ФФ	DUAL FACE CLOCK	(OS4)	DUAL TECHNOLOGY SENSOD 2000 4000 SO ET
	EMERGENCY PUSH STATION	VI	VIDEO INPUT	₩ ₩	DUAL TECHNOLOGY SENSOR - 360° - 1000 SQ FT
B B	CODE BLUE STATION	AV	AUDIO / VIDEO INPUT	\triangle	
Ā Ā	PENDENT INTERFACE	<u> </u>	BELL	(OS5)	DUAL TECHNOLOGY SENSOR - 360° - 500 SQ FT
] 	BED / LIGHT INTERFACE	$\overline{\mathbb{Q}}$	VOLUME CONTROL	*	
- 31	SINGLE BED STATION	B	BUZZER	ОС	SWITCH STYLE OCCUPANCY SENSOR
32	DUAL BED STATION	Ô	CHIME		
\leq	DOME LIGHT	Φ	TELEVISION OUTLET	PP	POWER PACK
RS	STAFF REGISTER STATION	\mathbf{M}	MICROPHONE OUTLET		
S S	STAFF STATION	①	INTERCOM OUTLET	\$⊤	DIGITAL TIME SWITCH
S	DUTY STATION		CAMERA		
	DESIGNATIONS	DC	DOOR CONTACT		FIRE ALARM
x>	DEMOLITION NOTE		MOTION DETECTOR	(2) (H)	SMOKE DETECTOR HEAT DETECTOR
\check{x}	PLAN NOTE		BEAM DETECTOR		DUCT SMOKE DETECTOR
$\tilde{\lambda}$	ADDENDUM NOTE	KP SSCP	KEY PAD	F/S	DUCT SMOKE DETECTOR
		SSCP CCTV	SECURITY SYSTEM CONTROL PANEL CCTV CONTROL PANEL	F/S — □ 1	HORN
					HORN & LIGHT
		CR	CARD READER		SPEAKER
		ss	STUDENT STATION	□o	SPEAKER & LIGHT
		AS	ADMINISTRATION STATION	Ē	PULL STATION
		TS	TEACHER STATION		FIRE ALARM CONTROL PANEL
		G□	GLASS BREAK	ANN	ANNUNCIATOR PANEL
				– EOL–	END OF LINE DEVICE
				♦ €	REMOTE INDICATING LIGHT, WALL MTD.
\sim \vdash	NEDAL ELECTRICAL	NOT	-0	 	REMOTE INDICATING LIGHT, CLG. MTD.
JE	NERAL ELECTRICA		<u> </u>	DH	MAGNETIC DOOR HOLDER
	LI WALL AND ELOOD DENETDATIONO	NDE TO DE 0	E41 ED T0	FC	FIREFIGHTER COMMUNICATION JACK
	ILL WALL AND FLOOR PENETRATIONS / IAINTAIN ORIGINAL RATING.	AKE IUBESI	EALED IO	Ē	FLOW SWITCH (furnished by FP/C)
11	" UNIONAL IVALINO.			+	TAMPER SWITCH (furnished by FP/C)
	ALL CONDUITS TO BE FIELD ROUTED AL	ONG EXISTIN	NG PIPING AND	$\boxed{\triangledown}$	VISUAL ONLY UNIT
S	TRUCTURAL STEEL.			FCPS	FIRE CONTROL POWER SUPPLY
3. T	HE DIVISION 26 CONTRACTORS SHALL	VISIT THE PI	ROJECT AND	M	MONITOR MODULE
С	ETERMINE THE EXACT EXTENT OF THE	E DEMOLITIO		©	CONTROL MODULE
F	EQUIRED BEFORE BIDDING THE PROJ	ECT.		$\langle M \rangle$	CARBON MONOXIDE DETECTOR
	SEMONE ALL EVICTIMO ODGOLETE EVIC	2055 20151	HT MUDE AND		

4. REMOVE ALL EXISTING OBSOLETE EXPOSED CONDUIT, WIRE AND

5. WHERE BUILDING SURFACES ARE DAMAGED BY THE REMOVAL OF OLD WORK, SURFACES SHALL BE PATCHED TO MATCH ADJACENT.

6. EXISTING WORK WHICH IS PRESENTLY CONCEALED AND WHICH WILL

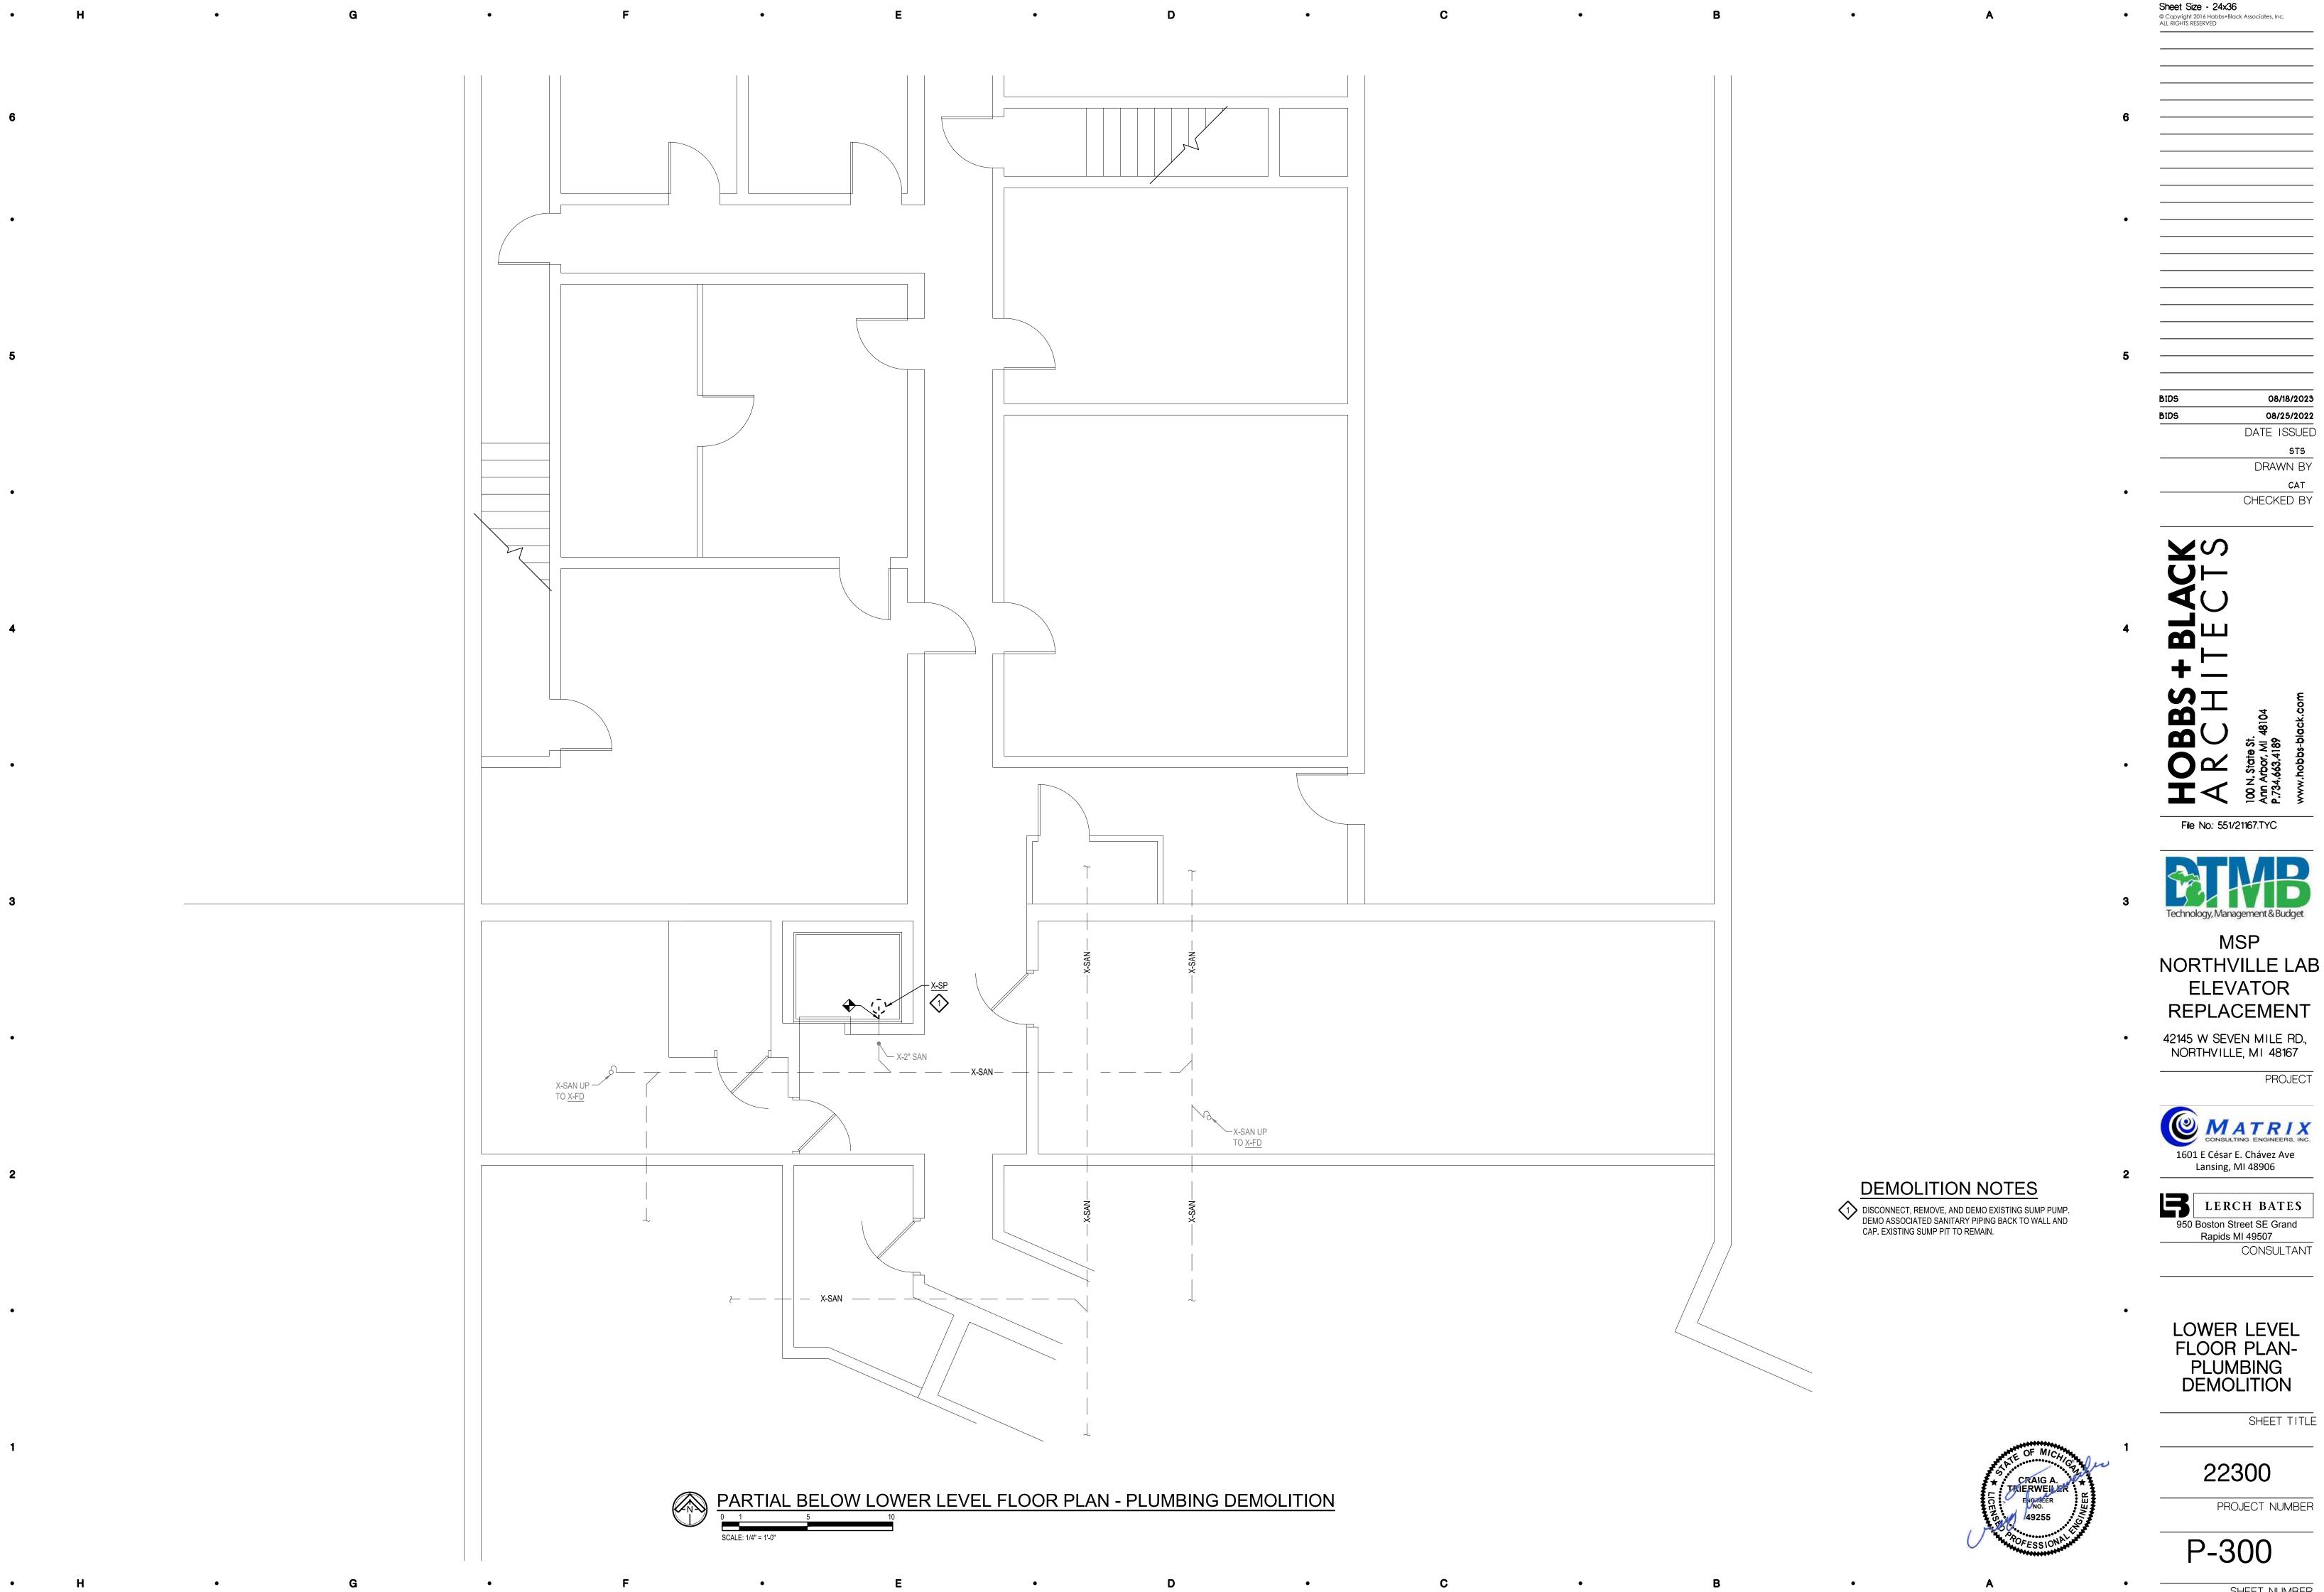WORK OF ANY TRADE NEED NOT BE REMOVED. HOWEVER, ALL

CONDUIT SHALL BE CAPPED BELOW FINISH SURFACE AND THEN

MODIFIED OR ENLARGED TO SUIT THE NEW SYSTEMS AS REQUIRED.

7. EXISTING OPENINGS, WHICH ARE TO BE REUSED, SHALL BE

8. IF ASBESTOS IS PRESENT, IT WILL BE REMOVED OR RENDERED HARMLESS UNDER SEPARATE CONTRACT BY THE OWNER.

9. THE DIVISION 26 CONTRACTOR SHALL BE RESPONSIBLE FOR

PATCHING THE EXISTING WALLS TO MATCH THE ADJACENT

10. CONTRACTOR SHALL FIELD VERIFY ALL EQUIPMENT VOLTAGES AND

CASUAL FIELD OBSERVATION. REPORT ANY DISCREPANCIES TO

12. CONTRACTOR SHALL KEEP CURRENT-CARRYING CONDUCTORS OF

DIFFERENT LOAD TYPES IN SEPARATE CONDUITS. LOAD TYPES

CONSIST OF, BUT ARE NOT LIMITED TO: RECEPTACLES, MOTORS,

SEPARATE CONDUITS. 120V, 208V, 240V, 277V, AND 480V CIRCUITS

SURFACES BEHIND ALL SURFACE MOUNTED EQUIPMENT.

LOADS PRIOR TO INSTALLING SERVICE TO EQUIPMENT.

11. DRAWINGS ARE BASED ON EXISTING RECORD DOCUMENT AND

13. CONTRACTOR SHALL KEEP DIFFERENT VOLTAGE CIRCUITS IN

PROVIDE ALL REQUIRED CUTTING AND PATCHING.

REMAIN CONCEALED AND DOES NOT INTERFERE WITH ANY NEW

NOTED OTHERWISE.

PATCHED TO MATCH, OR AS NOTED.

ENGINEER FOR CLARIFICATION.

EQUIPMENT, AND LIGHTING.

SHALL NOT BE COMBINED.

UNUSED EQUIPMENT WHERE WORK IS BEING DONE EXCEPT ITEMS

ABBREVIATIONS LEGEND

A AC ACU- AFF	AMPS ABOVE COUNTER AIR CONDITIONING UNIT ABOVE FINISHED FLOOR	GC GFI GND	GENERAL CONTRACTOR GROUND FAULT INTERUPTER GROUND	P P- PB PNL	POLE PUMP PULL BOX PANEL
AHJ AHU- AIC AS	AUTHORITY HAVING JURISDICTION AIR HANDLING UNIT AMPS INTERUPTING CAPACITY ABOVE SHELF	H- HID HOA	HUMIDIFIER HIGH INTENSITY DISCHARGE HAND-OFF-AUTO SELECTOR SWITCH	PRV- PVC PWR	POWER ROOF VENTILATOR POLY VINYL CLORIDE POWER
ATS B-	AUTOMATIC TRANSFER SWITCH BOILER	HP HR HVAC	HORSEPOWER HOUR HEATING/VENTILATING/AIR CONDITIONING	RECEPT RGC RTU-	RECEPTACLE RIGID GALVANIZED STEEL CONDUIT ROOF TOP UNIT
BC BLDG	BELOW COUNTER BUILDING	IG IMC	ISOLATED GROUND INTERMEDIATE METAL CONDUIT	SF- SPEC	SUPPLY FAN SPECIFICATIONS
CHLR- CND (C)	CHILLER CONDUIT	JB	JUNCTION BOX	SW SWBD	SWITCH SWITCHBOARD
CKT CKT BKR CT- CU- CUH-	CIRCUIT CIRCUIT BREAKER COOLING TOWER CONDENSING UNIT CABINET UNIT HEATER	LC LT LTG LT FLEX	LIGHT CONTROL LIGHT LIGHTING LIQUID TIGHT FLEXIBLE METAL CONDUIT	TCC TR TS TYP	TEMPERATURE CONTROL CONTRACTOR TAMPER PROOF RECEPTACLE TAMPER PROOF SWITCH TYPICAL
DFU- DISC DWG DWH-	DUCT FURNACE DISCONNECT DRAWING DOMESTIC WATER HEATER	MAX MC MCC MIN MLO	MAXIMUM MECHANICAL CONTRACTOR MOTOR CONTROL CENTER MINIMUM MAIN LUG ONLY	UF UH- UL UNO	UNDER FLOOR UNIT HEATER UNDERWRITERS' LABORATORIES, INC. UNLESS NOTED OTHERWISE
EBB- EC EF-	ELECTRIC BASEBOARD ELECTRICAL CONTRACTOR EXHAUST FAN	MT MTD MTG MUAU-	MOUNT MOUNTED MOUNTING MAKE-UP AIR UNIT	V VL W	VOLTS VERIFY LOCATION WITH OWNER WATTS
EM EMT EWC EXIST (E)	EMERGENCY ELECTRICAL METALLIC TUBING ELECTRIC WATER COOLER EXISTING	NC NIC NL	NORMALLY CLOSED NOT IN CONTRACT NIGHT LIGHT	W/ W/O WP	WITH WITHOUT WEATHER PROOF
FLA FLEX FLR	FULL LOAD AMPS FLEXIBLE CONDUIT FLOOR	NO NTS	NORMALLY OPEN NOT TO SCALE	XFMR	TRANSFORMER

	LIGHTING FIXTURE SCHEDULE									
TYPE	MANUFACTURER	CATALOG NO.	DESCRIPTION AND COMMENTS	DIMMING INFO	FIXTURE MOUNTING HEIGHT	LAMPS				
LA	COLUMBIA LIGHTING OR EQUAL	HEM4-50ML-DFA-EU	LED 4' WALL-MOUNTED, GASKETED FIXTURE.	-	USE EXISTING HEIGHT	4850 LUMENS 47W, 5000K LED				

FIRE ALARM NOTES

FLUORESCENT

FIRE/SMOKE **FURNACE**

FSES

FOOD SERVICE EQUIP. SUPPLIER

- 1. ALL POWER CABLE SHALL BE IN MINIMUM 3/4" CONDUIT UNLESS OTHERWISE SPECIFIED.
- 2. EXISTING FIRE ALARM SYSTEM IS HONEYWELL XLS1000.
- 3. FIRE ALARM CABLE CAN BE INSTALLED FREE AIR ABOVE CEILINGS.
- 4. PROVIDE RACEWAY WHERE SURFACE MOUNT DEVICES ARE REQUIRED. CONDUIT SHALL BE 3/4" MINIMUM.
- 5. ALL CABLE SHALL BE INSTALLED PER FIRE ALARM MANUFACTURER'S
- SPECIFICATIONS.
- 6. FIRE ALARM REMOTE POWER SUPPLY SHALL BE MONITORED.
- 7. PROVIDE SMOKE DETECTOR ABOVE ALL FIRE ALARM PANELS AND REMOTE POWER SUPPLIES.
- 8. REFER TO DRAWINGS FOR DEVICE QUANTITIES AND LOCATIONS. BRING TO THE ENGINEER'S ATTENTION DISCREPANCIES PRIOR TO BIDDING PROJECT.
- 9. UPON ALARM OF SMOKE DETECTORS, FIRE ALARM SYSTEM TO RELEASE DOOR HOLDERS.
- 10. POWER SUPPLIES IN BOTH FACP AND FCPS SHALL HAVE 25% SPARE CAPACITY.
- 11. TRUE PEER TO PEER NETWORK FOR FIRE ALARM SYSTEM.
- 12. FIRE ALARM CONTRACTOR IS RESPONSIBLE FOR ALL CANDELA RATINGS OF VISUAL UNITS TO COMPLY WITH NFPA 72. STROBE CANDELA SETTINGS SHALL BE SET DURING INSTALLATION OF THE DEVICE.
- 13. REPLACE ALL EXISTING DUCT DETECTORS AS SHOWN ON PRINTS. ANY DUCT DETECTORS THAT ARE DISCOVERED AND NOT SHOWN SHALL BE BROUGHT TO THE ENGINEER'S ATTENTION.
- 14. PROVIDE REMOTE TEST STATIONS FOR EACH DUCT DETECTOR.
- 15. INSTALLATION METHODS SHALL BE IN ACCORDANCE WITH THE NATIONAL ELECTRICAL CODE, ARTICLE 760.
- 16. 120V AC POWER FOR FIRE ALARM SYSTEM ENCLOSURES SHALL NOT SHARE CONDUIT RACEWAY WITH FIRE ALARM SYSTEM CIRCUITS.
- 17. FIRE ALARM SYSTEM DEVICES SHALL BE MOUNTED TO ELECTRICAL BOXES AS REQUIRED AND REFLECTED ON DEVICE INSTALLATION SHEET.
- 18. STROBE CANDELA SETTINGS SHALL BE SET DURING INSTALLATION OF
- THE DEVICE.
- 19. AREA SMOKE DETECTORS SHALL NOT BE PLACED WITHIN 36-INCHES OF AIR DISTRIBUTION DIFFUSERS OR RETURN GRILLS.

FIRE ALARM SEQUENCE OF WORK

- 1. SUBMIT SHOP DRAWINGS, WIRING DIAGRAMS, BATTERY CALCULATION TO ENGINEER ON LIGHTING AND FIRE ALARM SYSTEM.
- 2. SUBMIT FIRE ALARM SHOP DRAWINGS TO FIRE MARSHAL AFTER ENGINEER APPROVAL. INSTALL NEW LIGHTING PER DRAWINGS.
- 3. PROVIDE AND INSTALL FIRE ALARM SYSTEM PER APPROVED FIRE MARSHAL SUBMITTAL. TAG NEW DEVICES "OUT OF SERVICE" UNTIL NEW SYSTEM HAS BEEN APPROVED BY THE FIRE MARSHAL.
- 4. PROVIDE FIRE WATCH WHEN SWITCHING THE TAMPERS AND FLOW SWITCHES TO NEW SYSTEMS.
- 5. NEW FIRE ALARM SYSTEM SHALL BE CERTIFIED BY NICET LEVEL 3 FIRE ALARM SUPPLIER.
- 6. ENGINEER WILL PROVIDE PUNCH LIST ON LIGHTING AND FIRE
- ALARM SYSTEM. 7. OBTAIN FIRE MARSHAL APPROVAL FOR NEW FIRE ALARM SYSTEM. OBTAIN ELECTRICAL INSPECTION APPROVAL ON
- 8. TRAIN OWNER ON NEW SYSTEM.

LIGHTING AND POWER FOR PROJECT.

- 9. SUBMIT ALL O & E MANUALS AND AS-BUILTS TO ENGINEER FOR APPROVAL.
- 10. ONCE THE NEW SYSTEM HAS BEEN APPROVED, DEMO EXISTING FIRE ALARM SYSTEM. REMOVE ALL EXPOSED WIREMOLD, CONDUIT, AND WIRE. PATCH AND PAINT AS REQUIRED. REMOVE TAGS ON NEW FIRE ALARM DEVICES. TURN OVER O & E MANUALS AND AS-BUILTS TO OWNER.



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NORTHVILLE LAB **ELEVATOR** REPLACEMENT

42145 W SEVEN MILE RD., NORTHVILLE, MI 48167

PROJECT





ELECTRICAL SYMBOLS, ABBREV, NOTES, SCHEDULES

SHEET TITLE

PROJECT NUMBER

SHEET NUMBER


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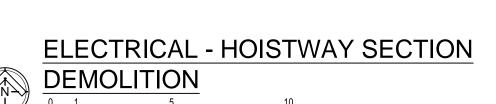
JOSEPH F.

SOVIS, JR.

ENGINEER NO.


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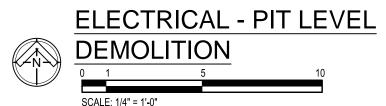


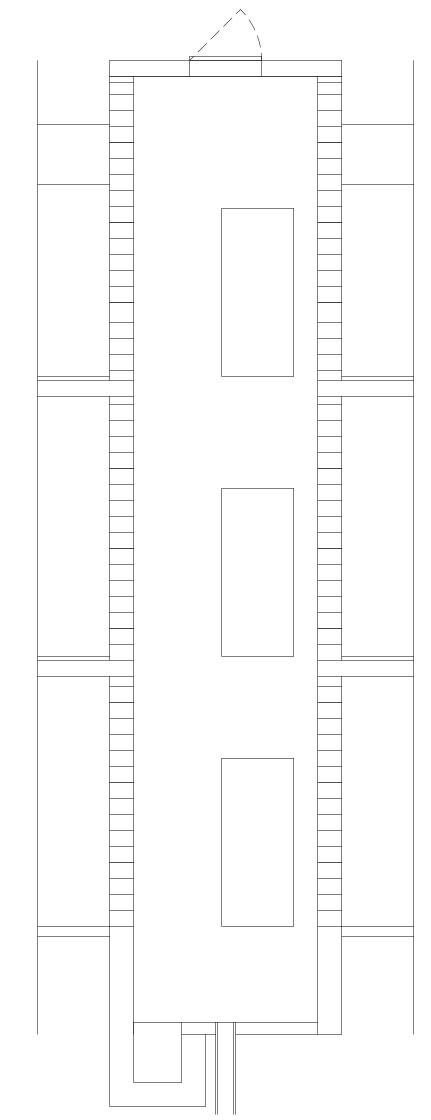



DEMOLITION NOTES


- 1 EXISTING LIGHT FIXTURE TO REMAIN.
- 2 EXISTING DEVICE TO REMAIN.
- 3 EXISTING EQUIPMENT TO REMAIN.
- DISCONNECT & REMOVE EXISTING LIGHT FIXTURE. REMOVE ASSOCIATED CONDUIT & WIRE.
- DISCONNECT & REMOVE EXISTING DEVICE. REMOVE ASSOCIATED CONDUIT & WIRE.
- DISCONNECT EQUIPMENT FOR REMOVAL BY OTHERS. REMOVE ASSOCIATED CONDUIT & WIRE.
- 7 DISCONNECT & REMOVE EXISTING EQUIPMENT. ASSOCIATED CONDUIT & WIRE TO REMAIN FOR NEW EQUIPMENT.




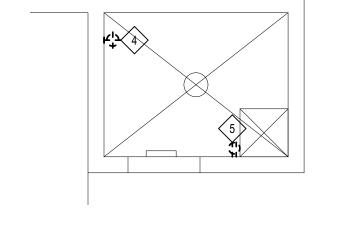


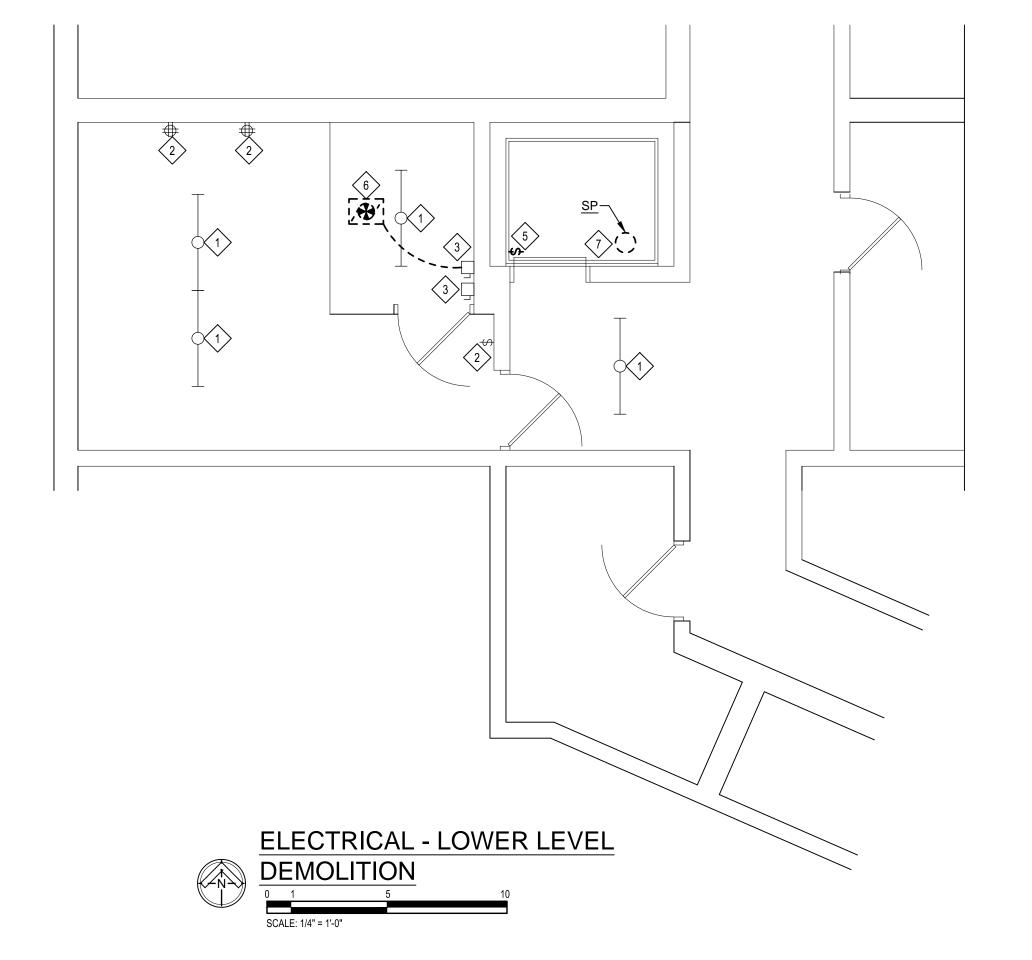


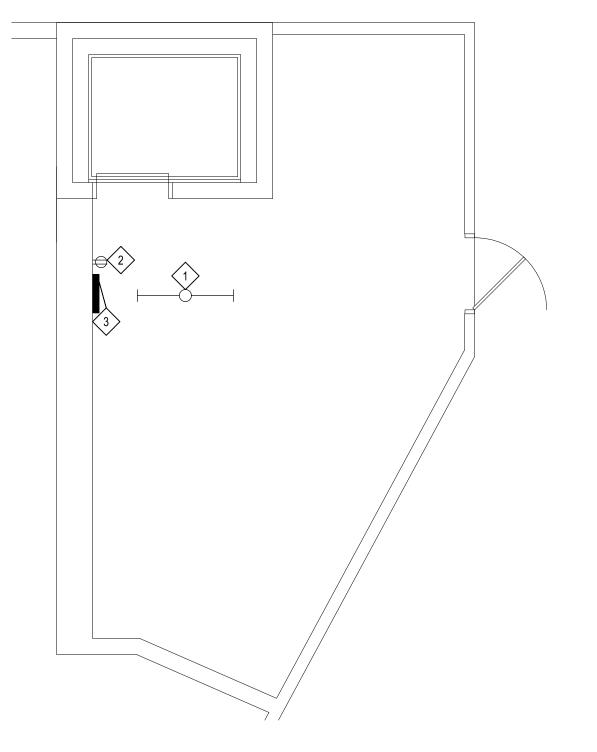

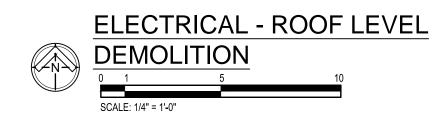

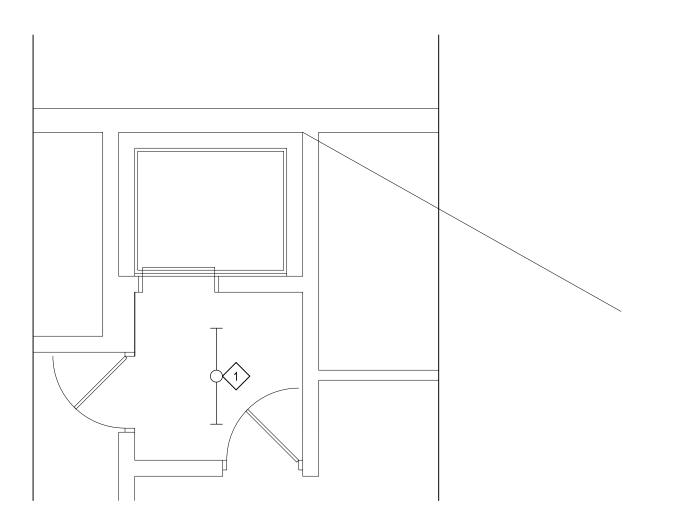

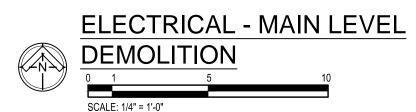

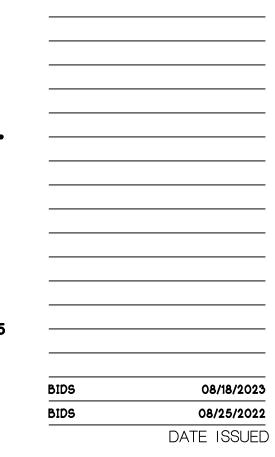

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File No.: 551/21167.TYC

MSP NORTHVILLE LAB ELEVATOR REPLACEMENT

42145 W SEVEN MILE RD., NORTHVILLE, MI 48167

PROJECT





ELECTRICAL DEMOLITION FLOOR PLANS

SHEET TITLE


22300

PROJECT NUMBER

E-300


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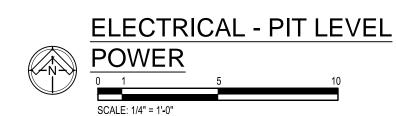
• G • F • E • D • C • B

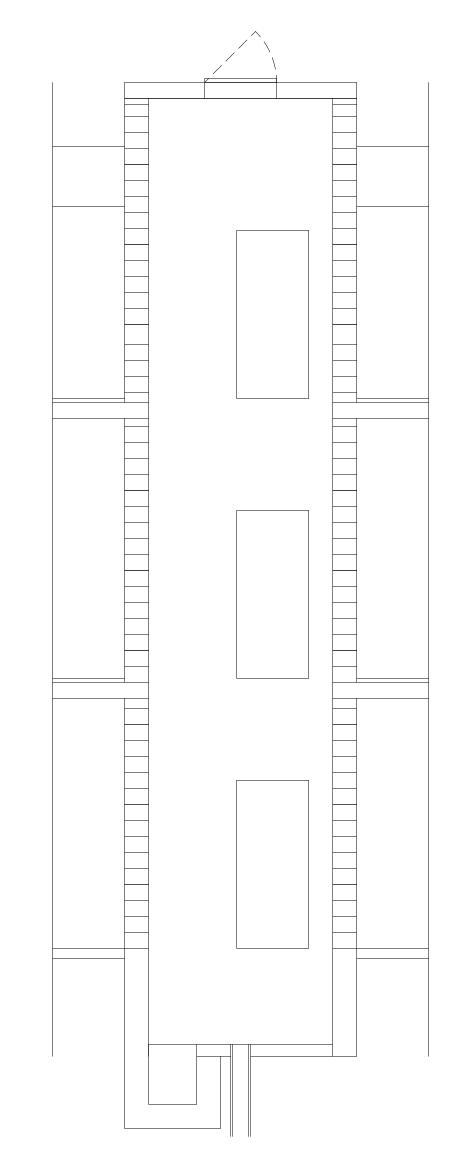


ELECTRICAL KEY NOTES


- 1) CONTRACTOR SHALL REUSE EXISTING CIRCUIT FOR LIGHT.
- 2 NEW SMOKE DETECTOR SUPPLIED BY OWNER. CONTRACTOR SHALL INCLUDE RELAYS TO MANAGE ELEVATOR RECALL SYSTEM. TIE DEVICE INTO EXISTING FIRE ALARM SYSTEM. DEVICE SHALL BE PROGRAMMED BY FIRE ALARM MANUFACTURER.
- (3) CONTRACTOR SHALL REUSE EXISTING CIRCUIT FOR NEW EQUIPMENT.
- CONTRACTOR SHALL CIRCUIT TO NEAREST AVAILABLE 120V-1P BREAKER. IF NO EXISTING BREAKERS ARE AVAILABLE, CONTRACTOR SHALL PROVIDE AND INSTALL NEW BREAKER IN EXISTING PANEL. NEW BREAKER SHALL MATCH EXISTING BREAKER TYPE.
- 5 NOT USED.
- 6 COORDINATE FINAL LOCATION OF CONTROL PANEL WITH SUMP PUMP LOCATION.
- 7 NEW HEAT DETECTOR SUPPLIED BY OWNER. CONTRACTOR SHALL INCLUDE RELAYS TO MANAGE ELEVATOR RECALL SYSTEM. TIE DEVICE INTO EXISTING FIRE ALARM SYSTEM. DEVICE SHALL BE PROGRAMMED BY FIRE ALARM MANUFACTURER.




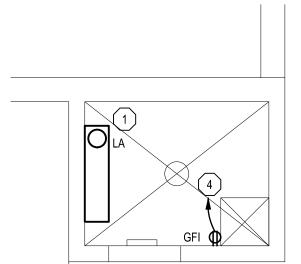





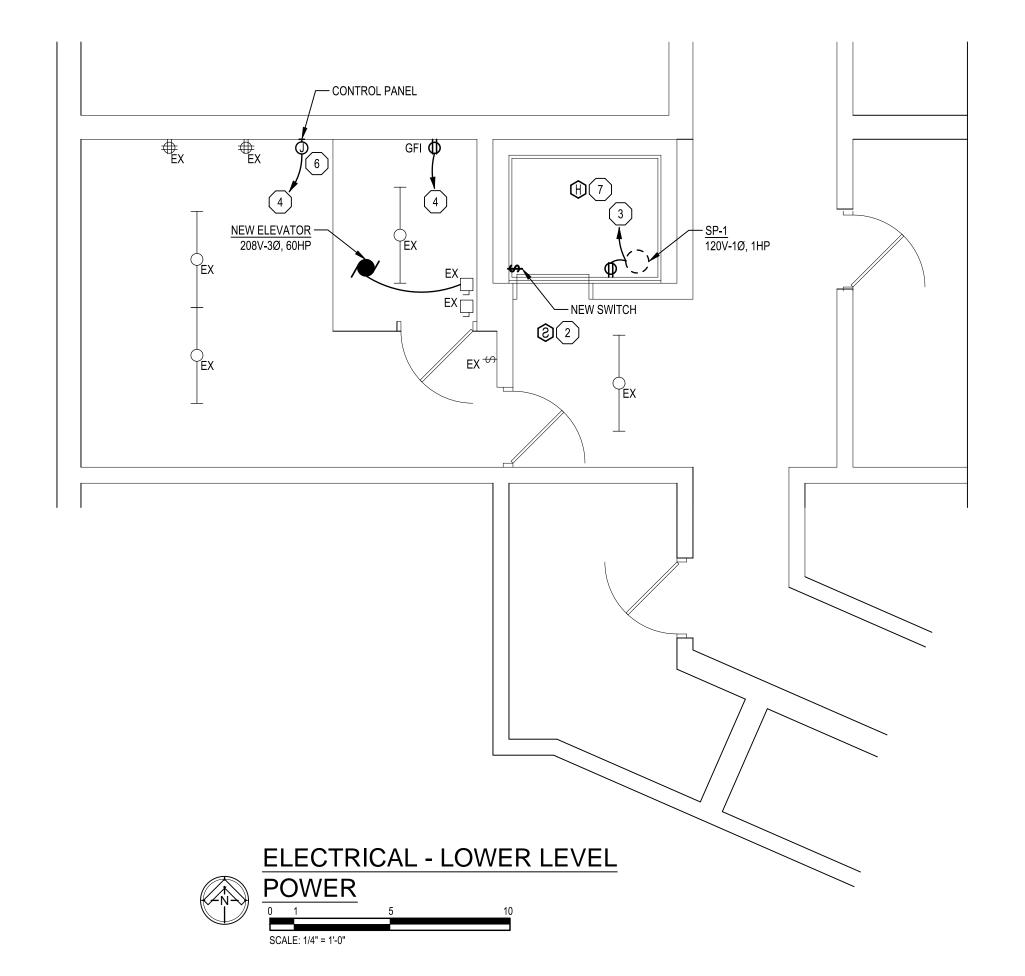


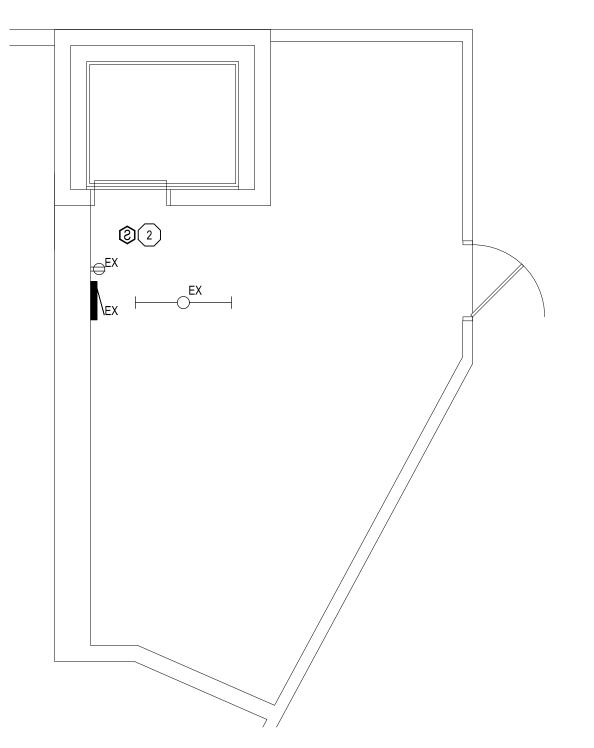

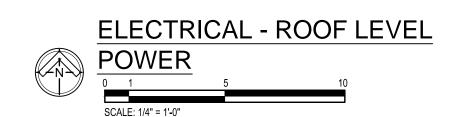

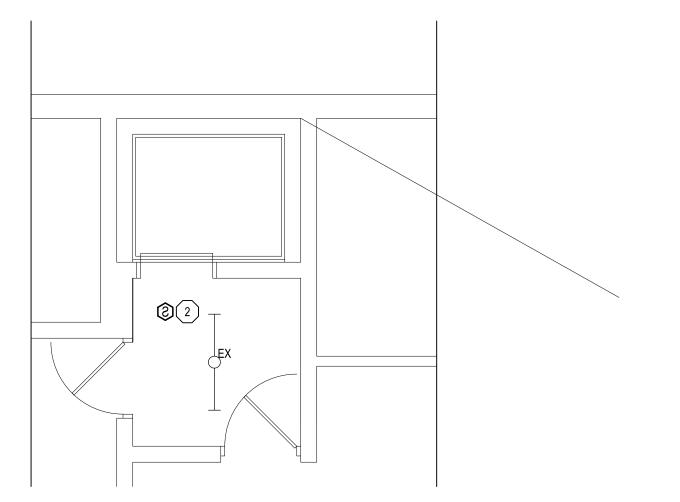

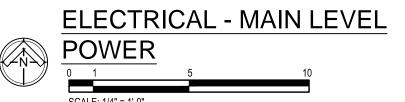

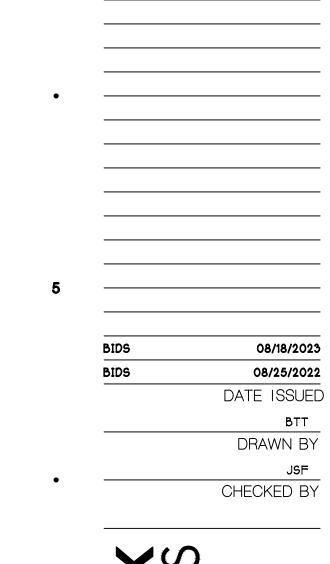

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MSP NORTHVILLE LAB ELEVATOR REPLACEMENT

42145 W SEVEN MILE RD., NORTHVILLE, MI 48167

PROJEC1





ELECTRICAL POWER FLOOR PLANS

SHEET TITLE


22300

PROJECT NUMBER

E-500

SHEET NUMBER

JOSEPH F. SOVIS, JR. S

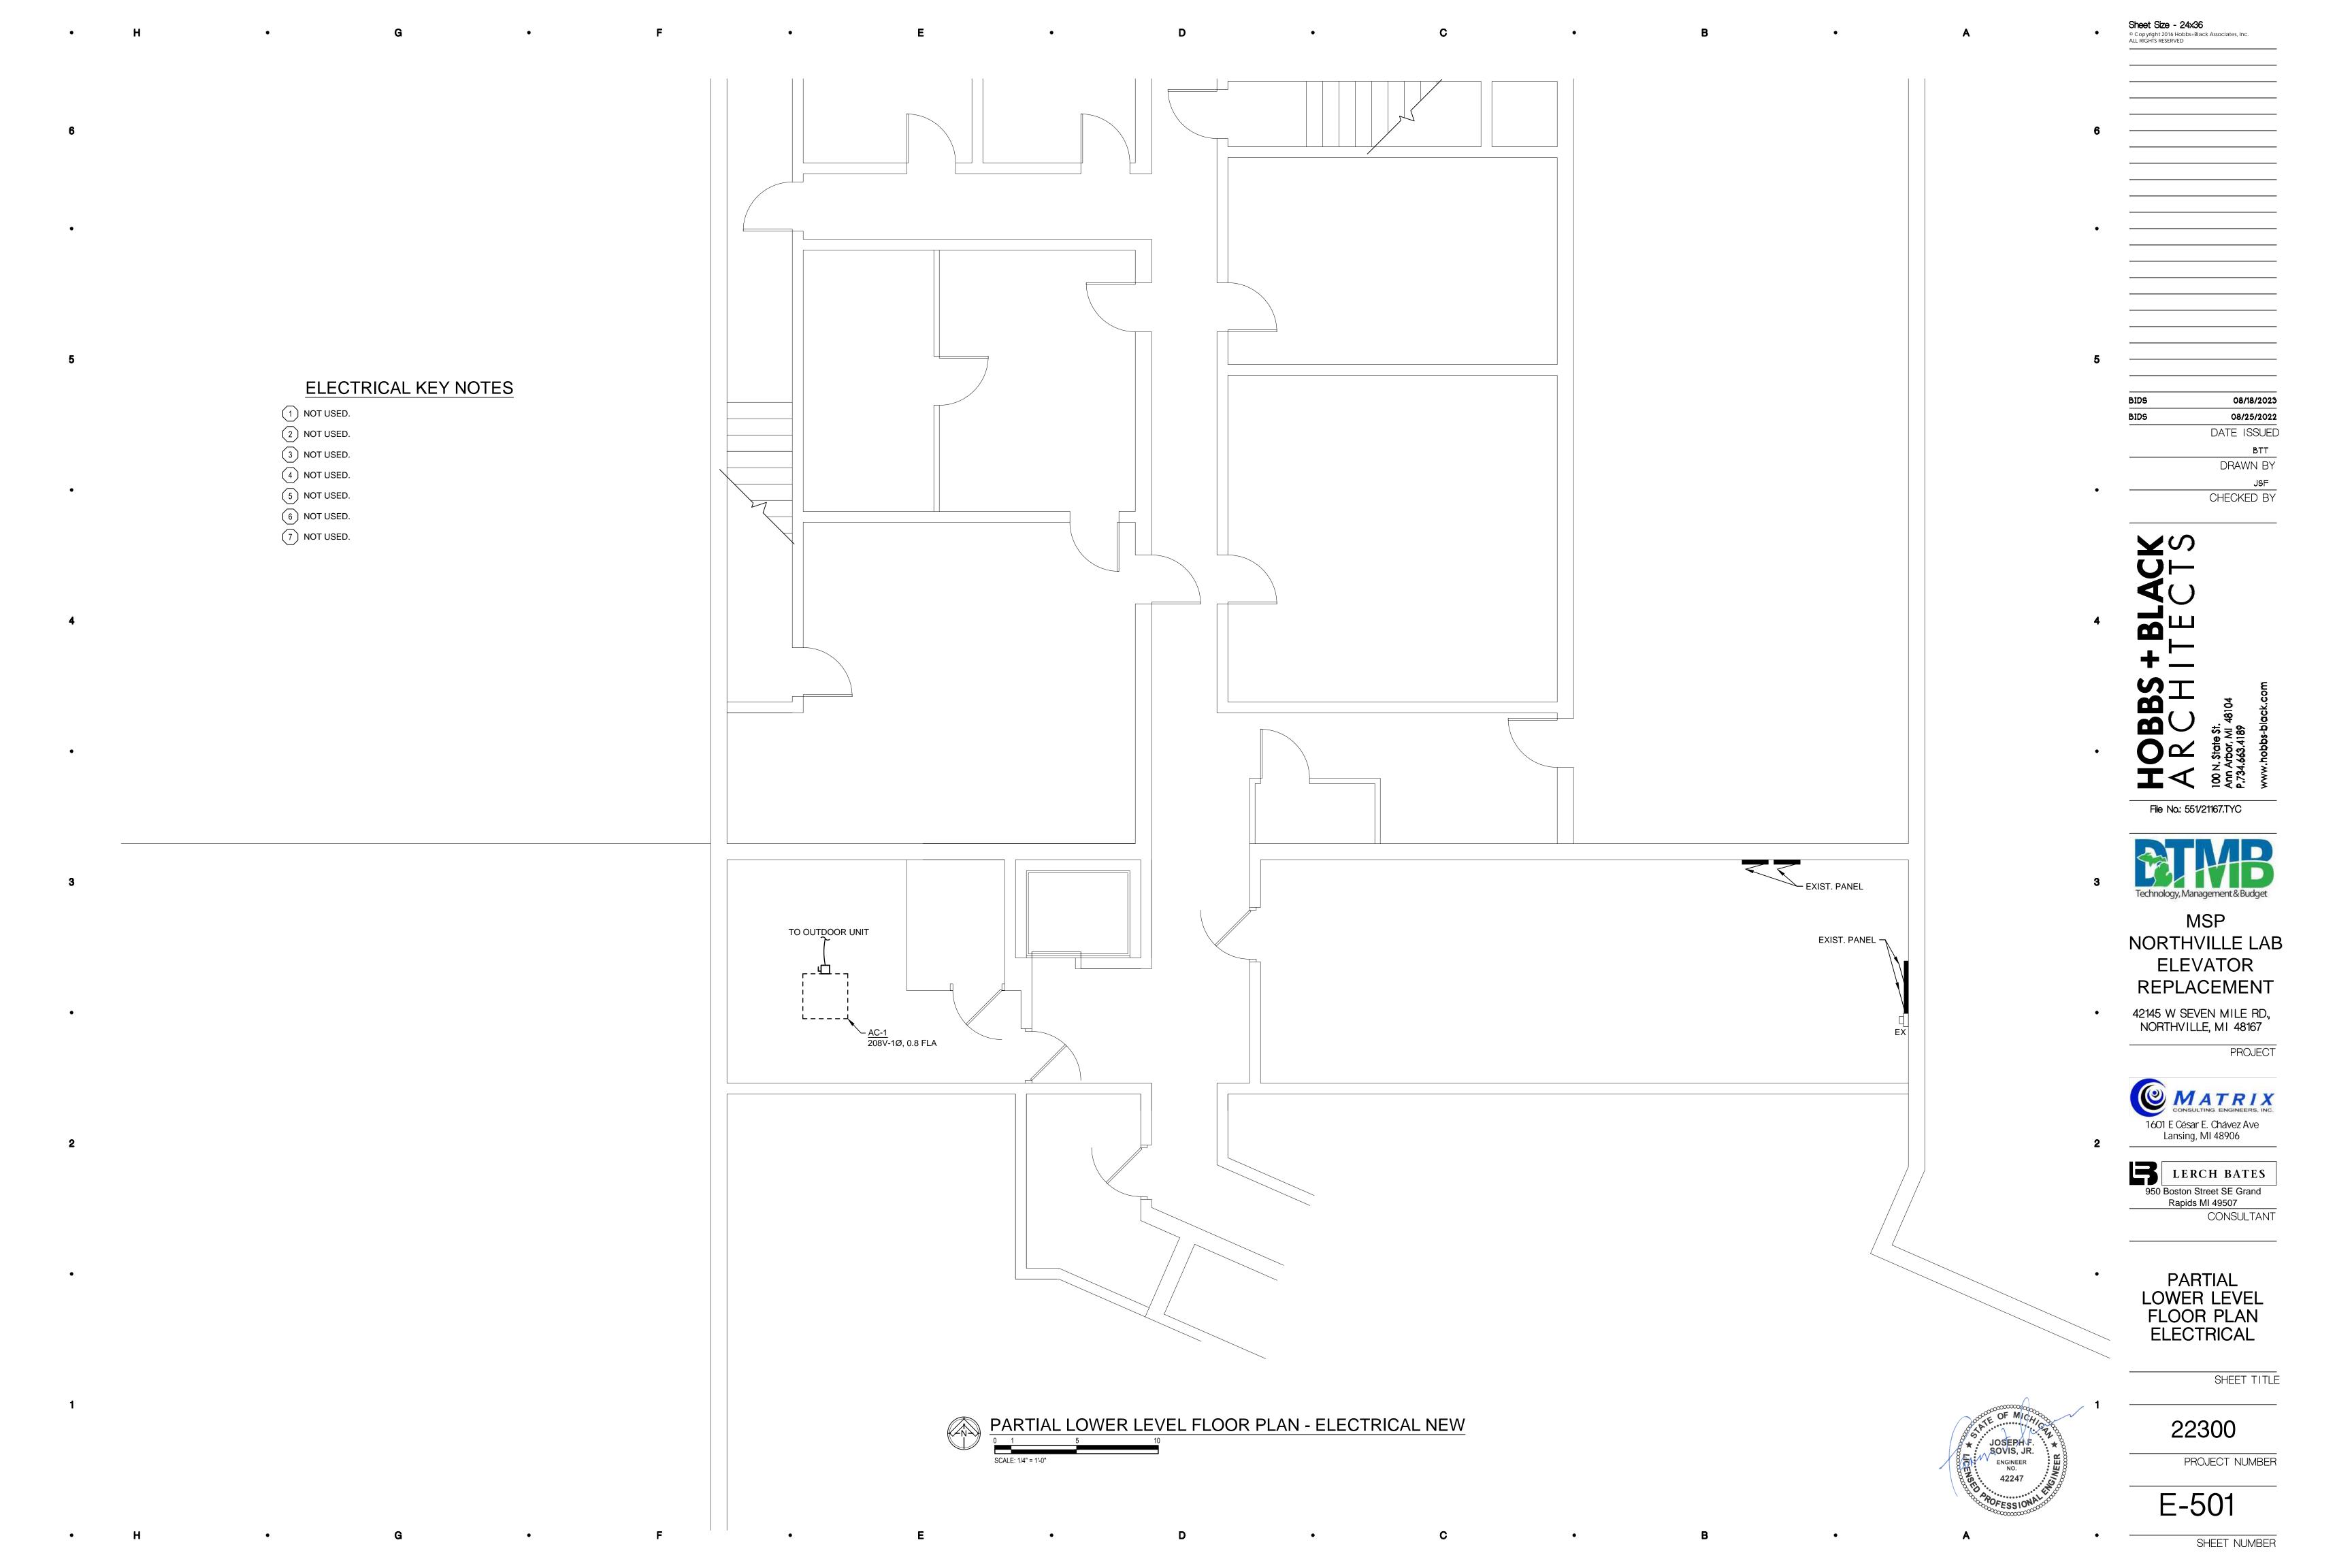

CU-1 208V-1Ø, 8.8 FLA WP 5 GFI

ELECTRICAL KEY NOTES

1 NOT USED.

2 NEW SMOKE DETECTOR SUPPLIED BY OWNER. CONTRACTOR SHALL INCLUDE RELAYS TO MANAGE ELEVATOR RECALL SYSTEM. TIE DEVICE INTO EXISTING FIRE ALARM SYSTEM. DEVICE SHALL BE PROGRAMMED BY FIRE ALARM MANUFACTURER.

3 NOT USED.

4 CONTRACTOR SHALL CIRCUIT TO NEAREST AVAILABLE 120V-1P BREAKER. IF NO EXISTING BREAKERS ARE AVAILABLE, CONTRACTOR SHALL PROVIDE AND INSTALL NEW BREAKER IN EXISTING PANEL. NEW BREAKER SHALL MATCH EXISTING BREAKER TYPE.

5 CONTRACTOR SHALL CIRCUIT TO NEAREST AVAILABLE 208V-1P BREAKER. IF NO EXISTING BREAKERS ARE AVAILABLE, CONTRACTOR SHALL PROVIDE AND INSTALL NEW BREAKER IN EXISTING PANEL. NEW BREAKER SHALL MATCH EXISTING BREAKER TYPE.

6 NOT USED.

7 NOT USED.

PARTIAL ROOF PLAN - ELECTRICAL NEW

SCALE: 1/4" = 1'-0"



BIDS 08/18/2023
BIDS 08/25/2022
DATE ISSUED
BTT

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MSP NORTHVILLE LAB ELEVATOR REPLACEMENT

 42145 W SEVEN MILE RD., NORTHVILLE, MI 48167

PROJECT



LERCH BATES
950 Boston Street SE Grand
Rapids MI 49507
CONSULTANT

PARTIAL ROOF PLAN ELECTRICAL

SHEET TITLE

22300

PROJECT NUMBER

E-502